# HARROW RECREATION RESERVE, HARROW - RECONSTRUCTION WORKS OF EXISTING COURTS TO TWO NEW MULTI PURPOSE NETBALL/TENNIS COURTS AND ONE TENNIS COURT.

# WEST WIMMERA SHIRE COUNCIL



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2240-29
PROJECT:
HARROW RECREATION RESERVE, HARROW
- PROPOSED REDEVELOPMENT WORKS OF
EXISTING COURTS - 2 MULTI PURPOSE
NETBALL/TENNIS & 1 TENNIS COURT

are not shown on plans and should be verified on site prior to commencement of any works

WARNING

UNDERGROUND SERVICES

**TENDER** 

CIVIL DRAWINGS

DRAWING TITLE: 2240-01

DRAWING INDEX & LOCALITY
PLAN

SHEET: 1 of 29 REVISION: A

## **STANDARD NOTES:**

- ALL WORKS ARE TO BE CARRIED OUT IN ACCORDANCE WITH THE CONSTRUCTION DRAWINGS, COUNCIL STANDARD DRAWINGS SPECIFICATIONS AND TO THE SATISFACTION OF COUNCIL'S SUPERVISING OFFICER OR HIS/HER APPOINTED REPRESENTATIVE.
- COUNCIL TO BE NOTIFIED SEVEN (7) CLEAR DAYS PRIOR TO COMMENCEMENT OF WORKS.
- ALL LEVELS SHOWN ARE TO A.H.D.
- PRIOR TO COMMENCEMENT OF WORKS ON SITE, THE CONTRACTOR MUST ENSURE THAT ALL MATTERS RELATING TO THE OCCUPATIONAL HEALTH & SAFETY ACT 2004 INCLUDING ALL RELEVANT REGULATIONS. HAVE BEEN ADDRESSED, IN PARTICULAR PREVENTION OF FALLS AND PLANT. DETAILS OF THE CONTRACTORS SITE MANAGEMENT PLAN INCLUDING OCCUPATIONAL HEALTH AND SAFETY PROCEDURES MUST BE LODGED WITH THE COUNCIL PRIOR TO COMMENCEMENT OF WORKS
- ON COMMENCEMENT OF CONSTRUCTION WORKS ON SITE, THE CONTRACTOR MUST COMPLY WITH THE RECOMMENDATIONS OF THE ENVIRONMENT PROTECTION AUTHORITY PUBLICATION "CONSTRUCTION TECHNIQUES FOR SEDIMENT POLLUTION CONTROL"
  - APPROPRIATE SILTATION CONTROL IS TO BE CARRIED OUT DURING THE CONSTRUCTION AND MAINTENANCE PERIOD
- NO EXCAVATION SHALL BE CARRIED OUT WITHIN THE CANOPY DRIP LINE OR 5.0M, WHICHEVER IS GREATER OF ANY EXISTING TREE UNTIL APPROVAL HAS BEEN GIVEN BY COUNCIL'S SUPERVISING OFFICER OR HIS/HER APPOINTED REPRESENTATIVE
- A TEMPORARY 1.8m CONSTRUCTION HIGH POST & WIRE FENCE SHALL BE ERECTED AND MAINTAINED AROUND EXISTING TREES, NOMINATED TO BE RETAINED AS PER A TREE PROTECTION ZONE (TPZ) CONDITION, AT ALL TIMES DURING CONSTRUCTION. UNDER NO CIRCUMSTANCES SHALL SITE SHEDS, VEHICLES, MACHINERY AND EQUIPMENT BE STORED OR PLACED WITHIN FENCED ZONE OF
- THE CONTRACTOR SHALL TO THE SATISFACTION OF THE CONSULTING ENGINEER AND COUNCIL'S REPRESENTATIVE PROVIDE AND MAINTAIN ALL NECESSARY WARNING SIGNAGE, LIGHTING AND BARRICADING TO COMPLY WITH THE REQUIREMENTS OF THE ROAD
- THE LOCATION OF EXISTING SERVICES SHOULD BE DETERMINED BY THE CONTRACTOR PRIOR TO COMMENCING ANY EXCAVATION BY CARRYING OUT A DBYD AND CONTACTING ALL RELEVANT SERVICE AUTHORITIES AND/OR THEIR AGENTS. ANY EXISTING SERVICES SHOWN ON THE DRAWINGS ARE OFFERED AS A GUIDE ONLY AND ARE NOT GUARANTEED AS CORREC
- SERVICE TRENCHES WITHIN THE ROAD RESERVE MUST BE BACKFILLED AS SPECIFIED BELOW, TO A DRY DENSITY NOT LESS THAN

  - 97% OF THE MAXIMUM FOUND IN THE STANDARD COMPACTION TEST FOR THE FOLLOWING:

    i. SERVICE TRENCHES BENEATH THE ROAD PAVEMENT, FOOTPATH OR DRIVEWAY CROSSOVER, TO THE UNDERSIDE OF THE PAVEMENT OR CROSSOVER BEDDING WITH 20MM CLASS 3 FCR WITH 3% CEMENT ADDITIVE.

    ii. DRAINAGE PIPES ADJACENT TO KERBING OR CONCRETE STRUCTURES WITH 20MM CLASS 4 FCR TO A LEVEL THAT IS NOT AFFECTED BY A 45 DEGREE ANGLE OF REPOSE FROM THE NEAR LOWER EDGE OF SUCH STRUCTURE, OTHERWISE TO FULL
- ALL EXCAVATIONS OF A DEPTH 1.5M OR GREATER MUST COMPLY WITH WORKCOVER VICTORIA. A "NOTICE OF INTENTION TO EXCAVATE..." FORM MUST BE SUBMITTED TO WORKCOVER 3 DAYS PRIOR TO THE WORK EXCAVATIONS.
  - CALL 1800 136 089 TOLL FREE **OR** 03) 9641 1444 TO OBTAIN FORM.
  - FAX FORM/S TO: 03) 9565 9400 **OR** 9941 0555.
- 13. ALL CONCRETE TO BE USED IN THE CONTRACT WORKS SHALL DEVELOP A MINIMUM COMPRESSIVE STRENGTH OF 25 MPA AT 28
- ALL DRAINAGE PIPES ARE TO BE REINFORCED CONCRETE CLASS 2 RUBBER RING JOINTED AS A MINIMUM UNLESS OTHERWISE APPROVED, ALL PVC PIPES TO BE CLASS SH UNLESS OTHERWISE APPROVED.
- 90mm DIA. AGRICULTURAL PIPE DRAINS TO BE PLACED BEHIND ALL KERB AND CHANNEL ON 20MM AGGREGATE BEDDING, 200MM BELOW SUBGRADE, AT GRADE AND WHERE DIRECTED BY THE CONSULTING ENGINEER.
- MINIMUM COVER TO OBVERT OF DRAINAGE PIPES SHALL BE 300MM IN EASEMENTS AND 500MM IN ROAD RESERVES, EXCEPT WHERE PIPE CLASS '4' WILL BE INSTALLED.
- 17. FILL AREAS ARE TO BE STRIPPED OF TOPSOIL, FILLED USING APPROVED CLAY FILL AND THEN TOPSOIL REPLACED TO OBTAIN FINAL FILL LEVELS AS SHOWN ON PLANS. ALL FILLING TO BE CARRIED OUT IN 150MM LAYERS AND COMPACTED TO 95% OF MAXIMUM DRY DENSITY IN ACCORDANCE WITH AS 3798-2007: GUIDELINES ON EARTHWORKS FOR COMMERCIAL AND RESIDENTIAL DEVELOPMENTS. ON COMPLETION AND AT THE DIRECTION OF COUNCIL OFFICER THE CONTRACTOR SHALL PRESENT A "LEVEL 1" TYPED REPORT NOMINATING THE EXTENT OF FILL PLACED, IT'S CONFORMANCE WITH THE SPECIFICATION AND ITS CLASSIFICATION AS CONTROLLED FILL". IF ANY SUBSTANDARD FILLING IS ENCOUNTERED ON THE SITE IT MUST BE REMOVED AND REPLACED WITH APPROVED FILL MATERIAL PROPERLY COMPACTED TO COUNCIL REQUIREMENTS. A GEO-TECHNICAL REPORT MUST BE SUBMITTED SHOWING DETAILS OF DEPTH, TYPE OF MATERIAL AND DENSITY OF THE FILL AREAS CONCERNED.
- THE CONTRACTOR IS RESPONSIBLE FOR ENSURING THAT ALL IMPORTED FILL MATERIAL, INCLUDING TOPSOIL, SATISFIES THE DESCRIPTION FOR CLEAN FILL MATERIAL IN EPA BUILLETIN PUBLICATION NO. 448 (SEPT '95) AND SUBSEQUENT REVISIONS. THE CONTRACTOR SHALL PROVIDE VERIFICATION INCLUDING TEST CERTIFICATES TO THE SUPERVISING ENGINEER
- BATTERS SHALL BE 1 IN 6 MINIMUM UNLESS OTHERWISE APPROVED AND COVERED AND SMOOTHED WITH MINIMUM OF 100MM
- 20. ROAD PAVEMENTS ARE TO HAVE A MINIMUM DEPTH OF 300MM INCLUDING SURFACING.


### 21. OPEN SPACE RESERVES:

- RESERVES TO BE EVENLY GRADED. SEEDED AND FREE DRAINING TO THE SATISFACTION OF RESPONSIBLE ALITHORITY.
- DESIGN INFORMATION TO INCLUDE RETICULATED WATER SUPPLY IN U/G PIT CONFIGURATION, BOLLARDS, SEATING. PLAYGROUND EQUIPMENT AND BBQ'S ETC. WHERE REQUIRED BY THE PERMI
- ALL NATURE STRIPS, EXCAVATED OR FILLED AREAS WITHIN THE ROAD RESERVE SHALL BE RESURFACED WITH A 100MM LAYER OF TOPSOIL AS SPECIFIED, FREE FROM CLAY AND STONE, EVENLY GRADED AND SEEDED TO THE SATISFACTION OF RESPONSIBLE
- ON COMPLETION THE CONTRACTOR IS RESPONSIBLE FOR THE REMOVAL OF ALL BUILDING WASTE, RUBBISH AND SPOIL FROM THE SITE, NO SURPLUS TREES, VEGETATION OR OTHER MATERIALS IS TO BE BURNT ON SITE.
- AS-CONSTRUCTED DATA INCLUDING ALTERATIONS DURING CONSTRUCTION ARE TO BE PROVIDED PRIOR TO ISSUE OF STATEMENT
  - DRAWINGS ARE TO BE IN A1 AND A3 HARDCOPY AND IN AUTOCAD (2010) AND ACROBAT PDF FORMATS.

- COUNCIL HOLD POINTS

  25. THE FOLLOWING HOLD POINT INSPECTIONS SHALL APPLY UNTIL WORKS ARE APPROVED BY COUNCIL'S SUPERVISING OFFICER.
  - CONSULTING ENGINEER/S TO BE PRESENT AT THESE HOLD POINTS;
  - 1) PRE-COMMENCEMENT OF WORKS SITE MEETING.
  - 2) SUBGRADE PROOF-ROLL PRIOR TO PLACEMENT OF SUB-BASE.
  - 3) SUB-BASE PROOF-ROLL PRIOR TO PLACEMENT OF BASE COURSE AND TEST RESULTS.
  - 4)BASE COURSE PROOF-ROLL PRIOR TO SEALING AND TEST RESULTS.
  - 5) PRIOR TO TRENCH BACKFILLING:
  - STORM WATER DRAINAGE, INCLUDING SUBSOIL AG DRAINS, AND
  - PROPERTY CONNECTIONS.
  - 6) FOOTPATH, DRIVEWAY AND KERB AND CHANNEL PRIOR TO PLACEMENT OF CONCRETE.
  - 7)INSPECTION AT PRACTICAL COMPLETION OF THE WORKS (COMMENCEMENT OF DEFECTS LIABILITY PERIOD). 8) 2ND INSPECTION AT THE END OF 12 MONTHS (END OF DEFECTS LIABILITY PERIOD).

# **LEGEND**

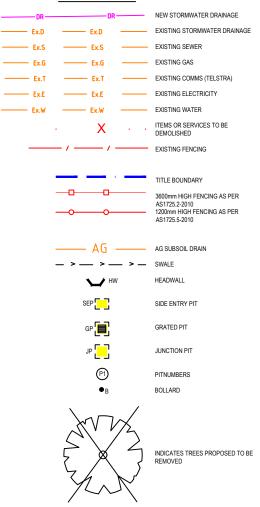



WARNING

UNDERGROUND SERVICES The location of underground services are not shown on plans and should be verified on site prior to commencement of any works

				DESIGNED:		DATE:	31-10-2022	
				DRAWN:		SHEET SIZE:	А3	
				CHECKED: G. DEVENISH		SCALE:	NOT TO CCALE	
Α	ISSUED FOR COMMENTS	G.DEVENISH	04.11.22	APPROVED:	G. DEVENISH		NOT TO SCALE	







PROJECT:
HARROW RECREATION RESERVE, HARROW
- PROPOSED REDEVELOPMENT WORKS OF
EXISTING COURTS - 2 MULTI PURPOSE
NETBALL/TENNIS & 1 TENNIS COURT


**CIVIL DRAWINGS** DRAWING TITLE: 2240-02

**GENERAL NOTES** 

SHEET: 2 of 29 REVISION:

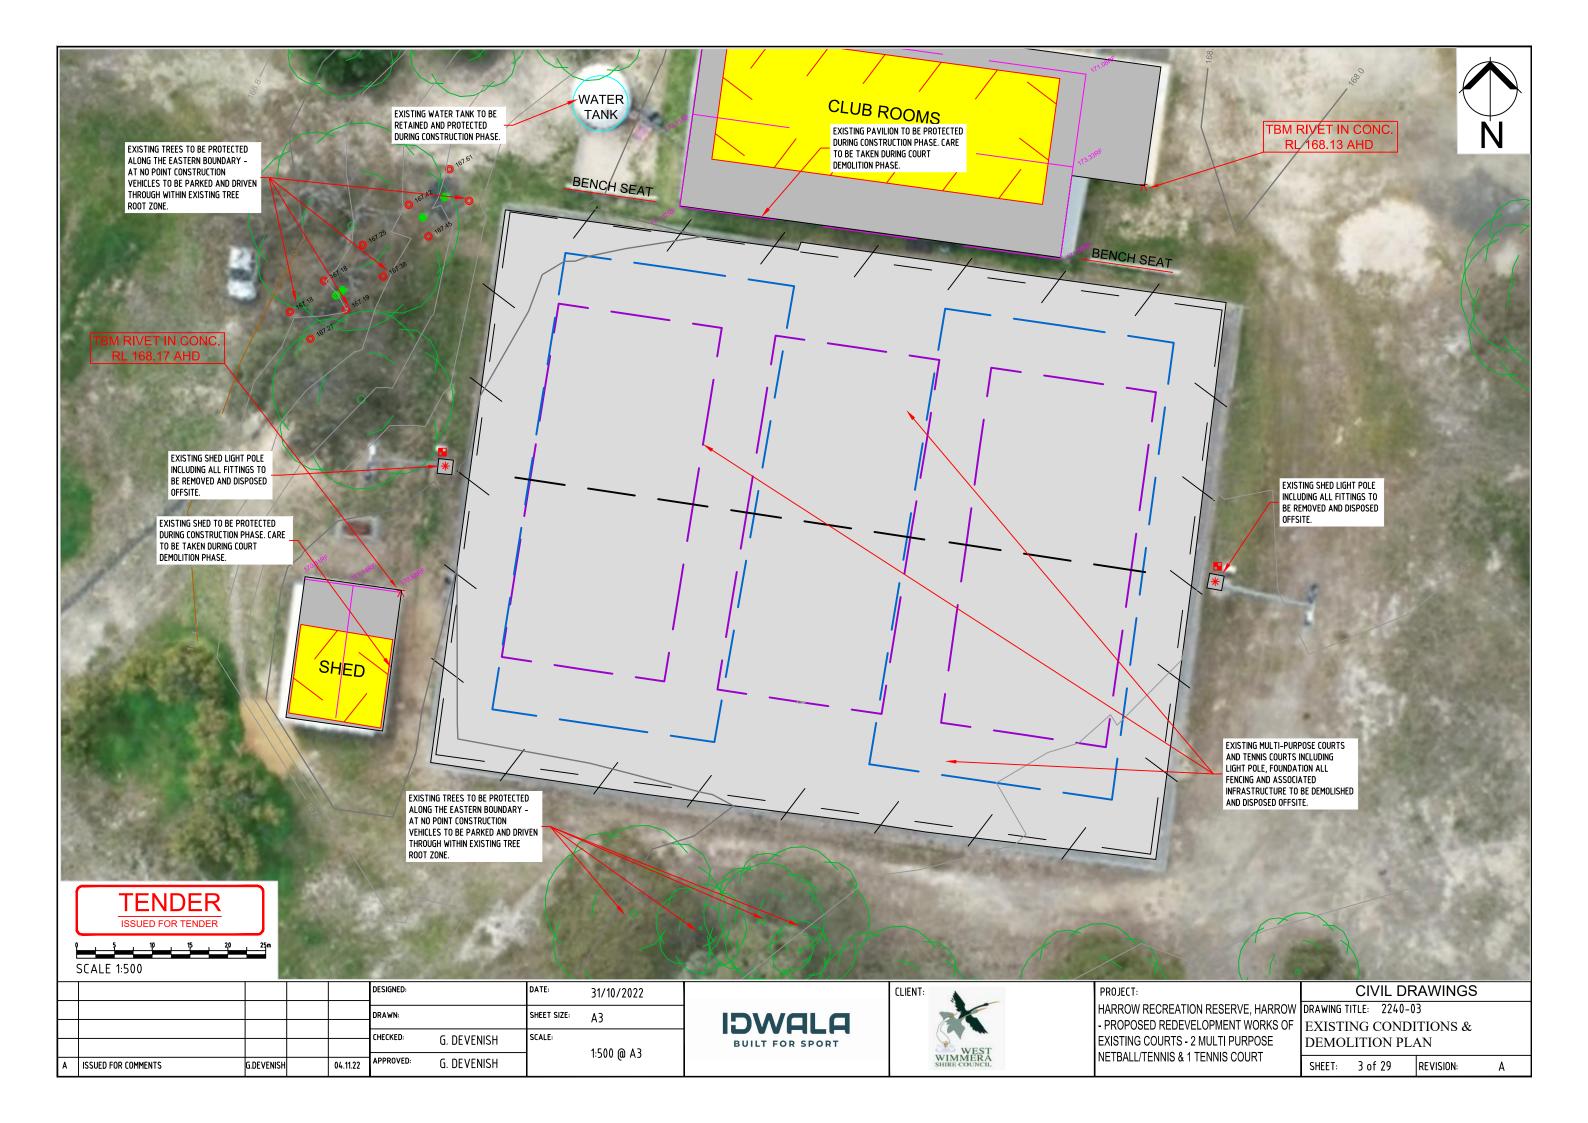

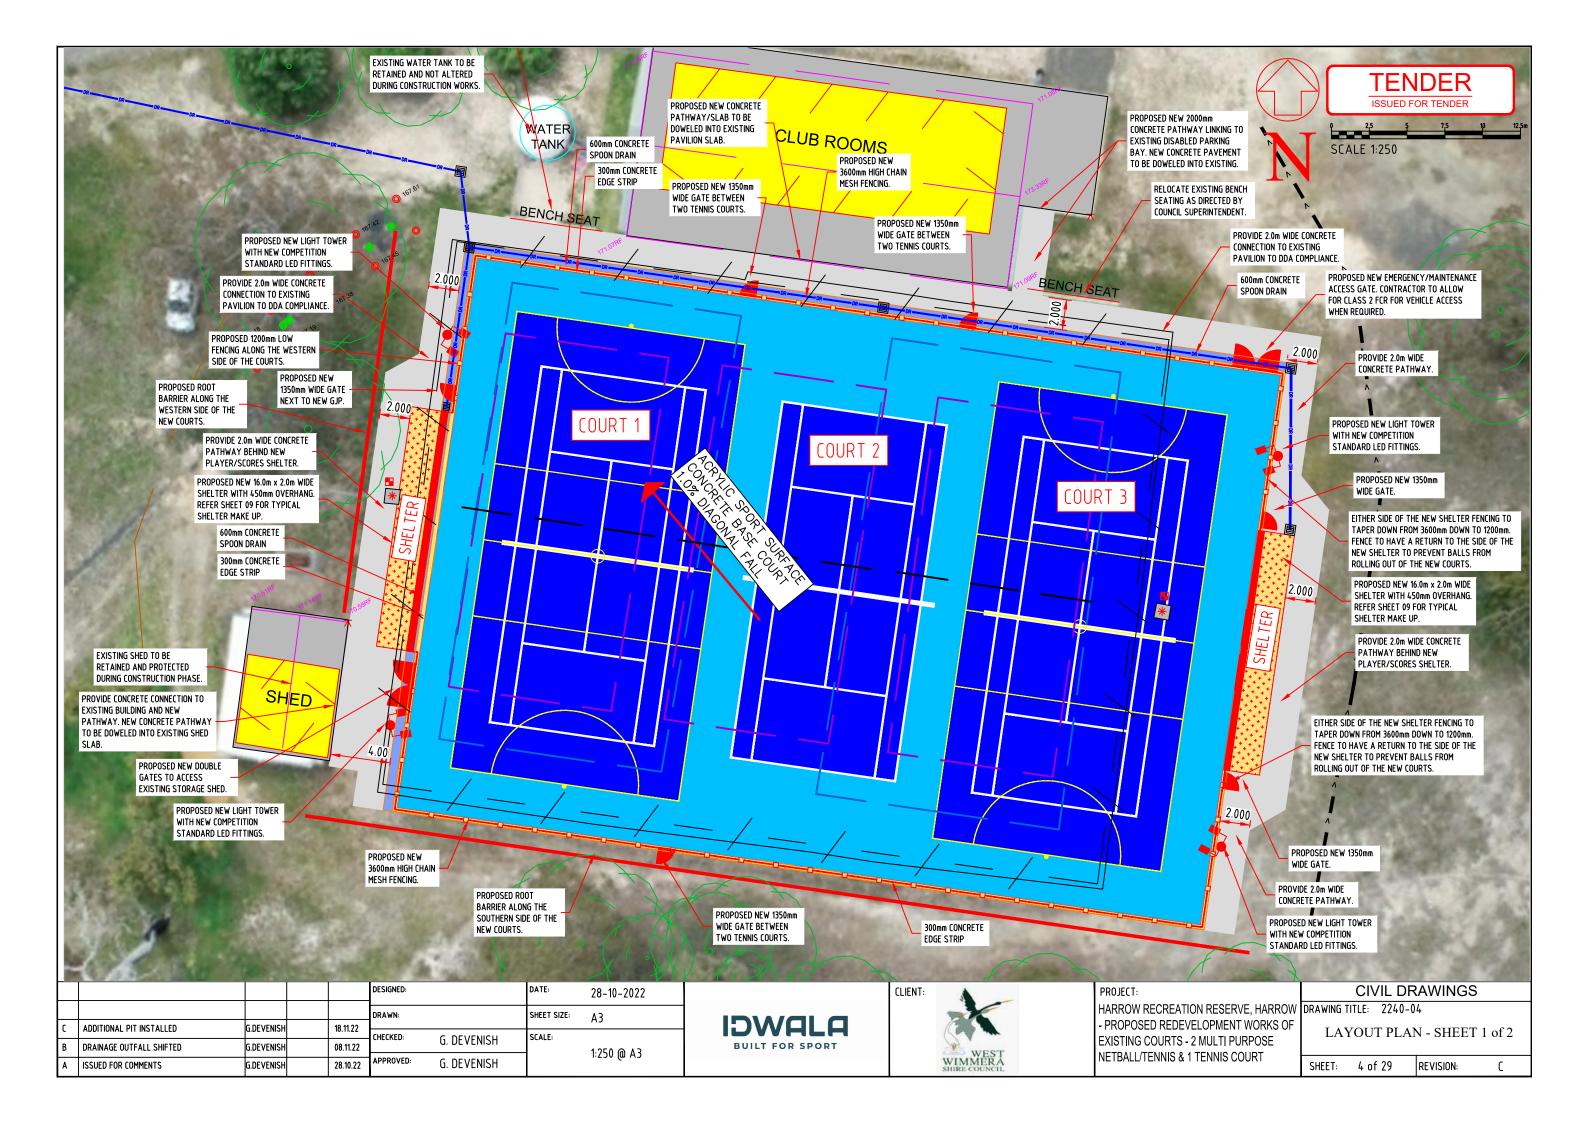

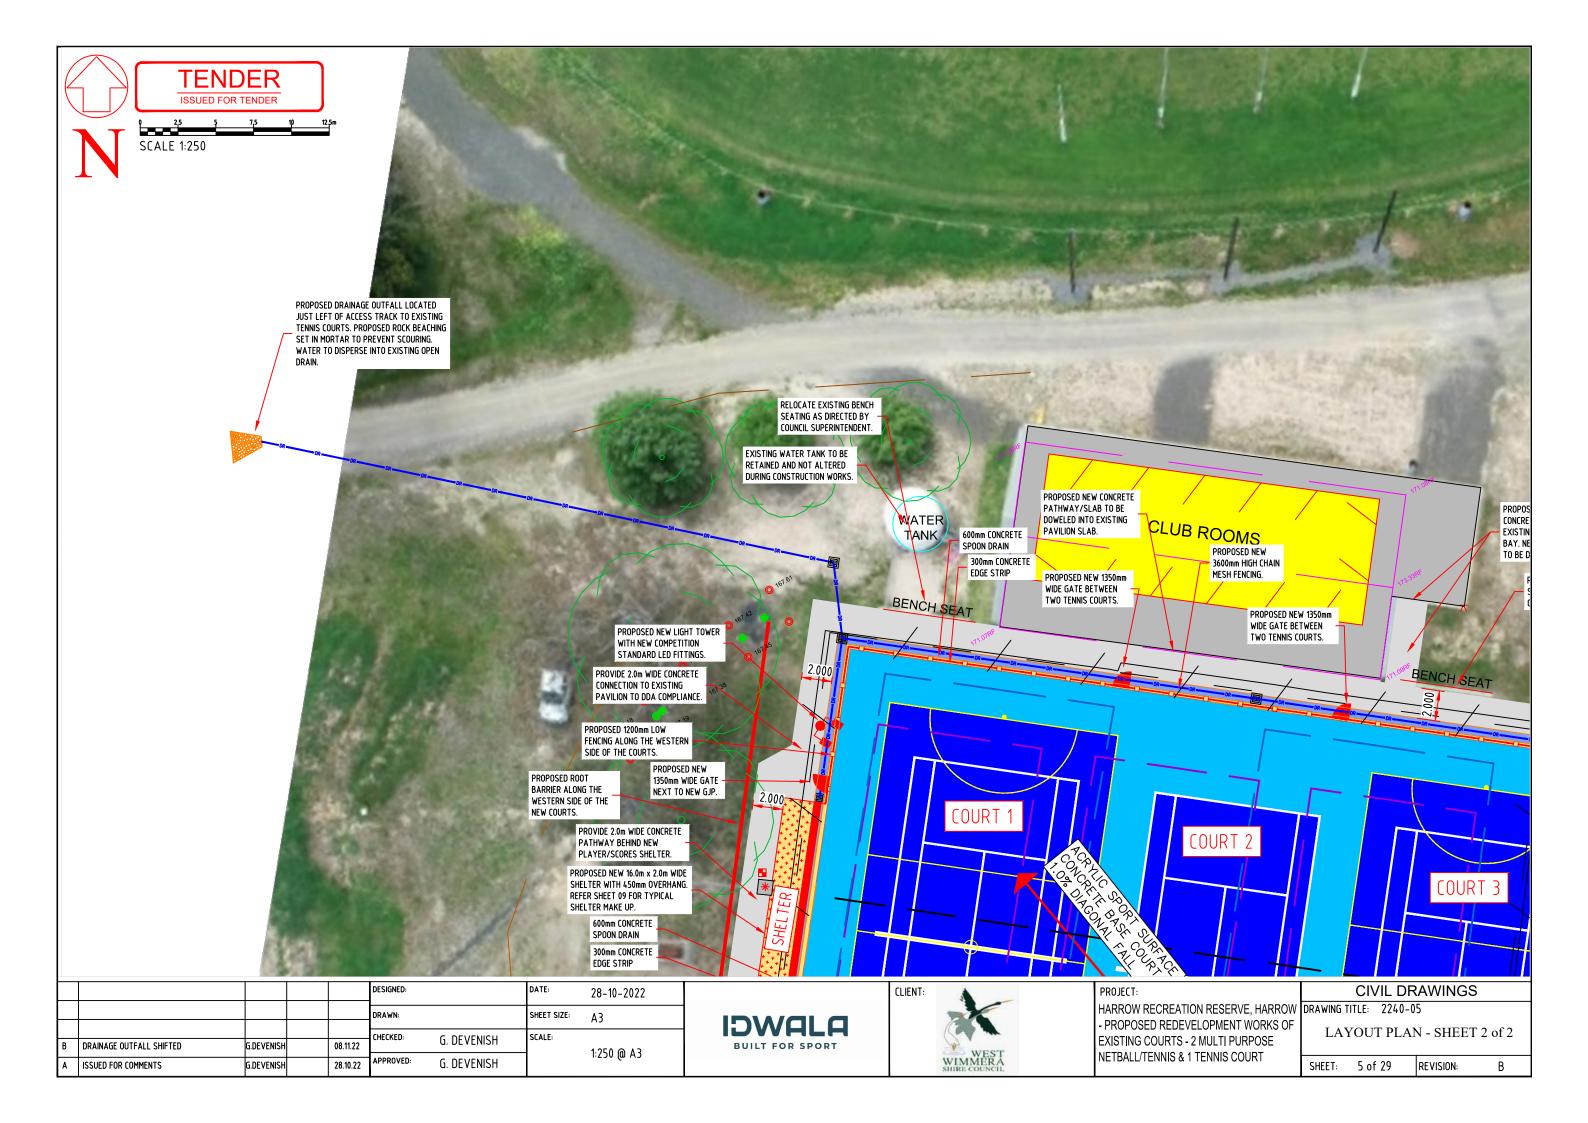

### LINE MARKING INFORMATION:

### NETBALL COURT LINE MARKING:

LINE MARKINGS SHALL BE PAINTED USING AN APPROVED WATER BASED YELLOW LINE MARKING ACRYLIC PAINT. LINE MARKING PAINT MUST BE APPROVED FOR ACRYLIC SURFACE AND BE GUARANTEED NOT TO CAUSE CRACKING, CURLING OR DAMAGE TO THE UNDERLYING ACRYLIC SURFACE. ALL MEASUREMENTS ARE MADE TO THE OUTSIDE OF THE LINES. ALL LINE MARKINGS SHALL CONFORM TO THE AUSTRALIAN STANDARD DIMENSIONS OUTLINED WITHIN THE ATTACHED TECHNICAL SPECIFICATION BEING COURT DIMENSIONS OF 30.50m LONG x 15.25m WIDE. ALL SIDELINE AND BASELINE RUN-OFF ZONES MUST BE A MINIMUM 3.05m AND BETWEEN COURT A MINIMUM OF 3.65m. ALL LINES SHALL BE 50mm WIDE WITH A TOLERANCE OF +/- 1.5mm.

### TENNIS COURT LINE MARKING:

LINE MARKINGS SHALL BE PAINTED USING AN APPROVED WATER BASED WHITE LINE MARKING ACRYLIC PAINT. LINE MARKING PAINT MUST BE APPROVED FOR ACRYLIC SURFACE AND BE GUARANTEED NOT TO CAUSE CRACKING, CURLING OR DAMAGE TO THE UNDERLYING ACRYLIC SURFACE. ALL MEASUREMENTS ARE MADE TO THE OUTSIDE OF THE LINES. ALL LINE MARKINGS SHALL CONFORM TO THE AUSTRALIAN STANDARD DIMENSIONS OUTLINED WITHIN THE ATTACHED TECHNICAL SPECIFICATION.

### MULTI PURPOSE COURT SURFACING:

### **ACRYLIC SURFACING**

A NON-SLIP ACRYLIC SURFACE SUITABLE FOR NETBALL COURT SURFACING IS REQUIRED TO BE SUPPLIED AND APPLIED.

THE ACRYLIC SURFACE APPLICATION PROCEDURES SHALL BE UNDERTAKEN AS PER THE MANUFACTURERS SPECIFICATIONS AND INSTRUCTIONS. THE SURFACE TOLERANCES OF THE FINISHED ACRYLIC SURFACE SHALL NOT EXCEED 3MM OVER A 3METRE LENGTH – TESTED VIA A STRAIGHT EDGE.

THE ACRYLIC RESIN SURFACE IS TO BE APPLIED TO THE ENTIRE CONCRETE COURT BASE OF THE 2 NETBALL COURT CONSTRUCTION. THE COLOUR OF THE ACRYLIC SURFACE SHALL BE LAYKOLD <u>LIGHT BLUE</u> SURROUNDS (RUNOFF ZONE AREA) AND LAYKOLD ARCTIC BLUE FOR PLAYING AREA OR EQUIVALENT. THE CONTRACTOR WILL BE REQUIRED TO PRESENT COLOUR CHARTS TO THE SITE SUPERVISOR TO CONFIRM COLOUR SELECTION PRIOR TO ORDERING.


THIS SPECIFICATION COVERS THE SUPPLY AND INSTALLATION OF A NON-SLIP ACRYLIC RESIN SURFACE OVER A NEW CONCRETE BASE AND THE INSTALLATION OF NETBALL COURT LINES AS PER NETBALL VICTORIA'S SLIP RESISTANCE RECOMMENDATIONS WITHIN THE NETBALL VICTORIA'S COMPLIANCE FACT SHEET. TENNIS COURT LINES AS PER TENNIS VICTORIA'S STANDARDS.


### **TOP COAT APPLICATION:**

THE CONTRACTOR IS TO APPLY THE SPECIFIED NUMBER OF TOP COATS AS PER THEIR SELECTED METHODOLOGY AND AS PER THE MANUFACTURERS RECOMMENDATIONS.

THE CONTRACTOR IS TO ENSURE THAT THE CONCRETE SURFACE IS THOROUGHLY SWEPT AND CLEAN BEFORE APPLYING THE TOP COAT(S). SURFACE TEMPERATURE LIMITS, WEATHER CONDITIONS AND MINIMUM TIMES BETWEEN COATS, RECOMMENDED BY THE MANUFACTURER, MUST BE OBSERVED. THE COMPLETED COURT SURFACING WORKS SHALL COMPLY WITH SURFACE

TOLERANCES THAT DO NOT EXCEED 3mm OVER A 3 metre LENGTH.

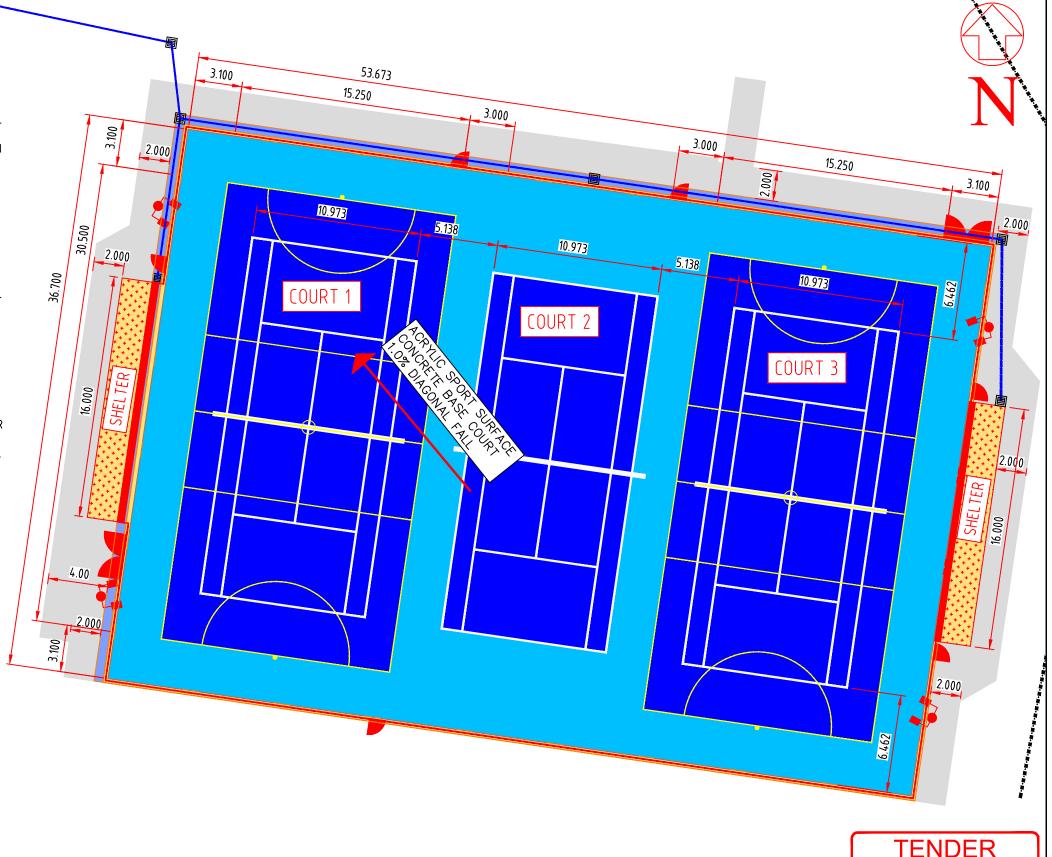

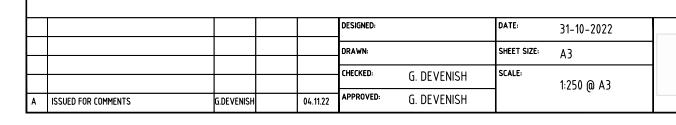






PROJECT:	CIVIL
HARROW RECREATION RESERVE, HARROW	DRAWING TITLE: 224
- PROPOSED REDEVELOPMENT WORKS OF	NETBALL/TENN
EXISTING COURTS - 2 MULTI PURPOSE	LAYOUT & LINE
NETBALL/TENNIS & 1 TENNIS COURT	
INETBALL/TEININIS & TTEININIS COURT	SHEET: 6 of 29

CIVIL DRAWINGS									
AWING TITLE: 2240-06									
NETBALL/TENNIS COURT DIMENSIONAL LAYOUT & LINE MARKING PLAN									

REVISION:

SCALE 1:250

ISSUED FOR TENDER

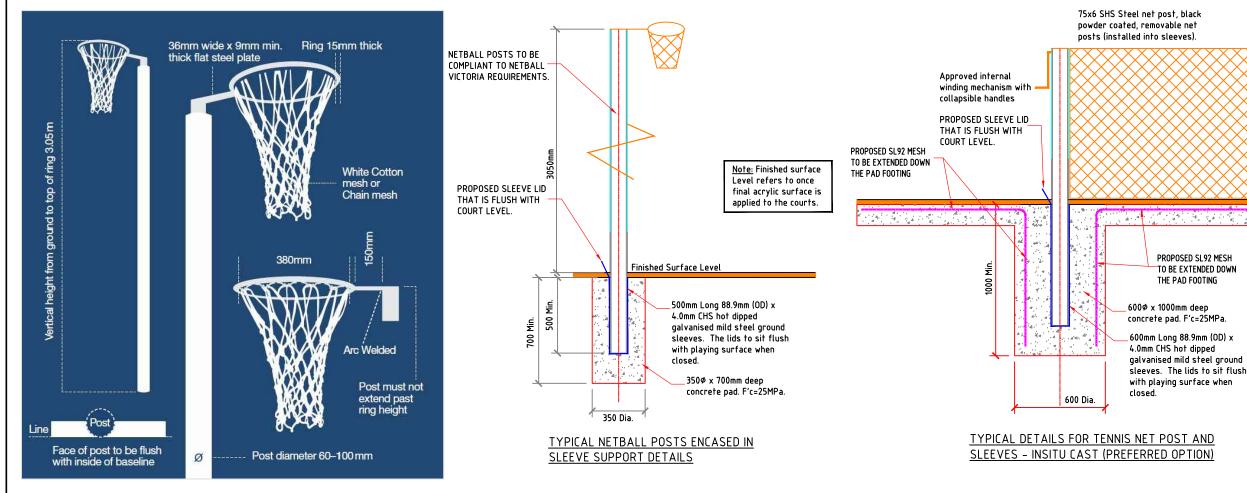

### NETBALL COURTS GOAL POST NOTES:

NETBALL COURTS MUST BE COMPLIANT TO CURRENT STANDARDS AS NOTED IN THE NETBALL AUSTRALIA TECHNICAL MANUAL SECTION 2 AND NETBALL VICTORIA COMPLIANCE FACT SHEET.

THIS PARTICULAR PROJECT REQUIRES THE FOLLOWING CLARIFICATIONS WHERE OPTIONS ARE PROVIDED:

1. GOAL POSTS MUST BE ROUND AND THE POST, RING AND CONNECTIONS WHITE POWDER COATED.

### **CONTRACTOR TO NOTE**

- 2. NETBALL COURTS: INSTALL 4 NEW HOT DIPPED GALVANISED (MILD STEEL) INTO GROUND SLEEVES. SLEEVES TO BE 500mm LONG 88.9mm (OD)x4.0mm CHS. THE GOAL POSTS ARE TO HAVE RING HEIGHT SETTINGS OF 3050mm ABOVE THE FINISHED SURFACE. THE SLEEVES ARE TO INCORPORATE A HINGED HOT DIPPED GALVANISED (MILD STEEL) CAP (FLAP) WHICH WHEN IN THE CLOSED POSITION IS TO SIT PERFECTLY FLUSH WITH THE NETBALL COURT SURFACE SO AS NOT TO PROVIDE A TRIP HAZARD. SLEEVE CAPS MUST BE SURFACED WITH THE SAME ACRYLIC AS THE SURROUNDING COURT SURFACE.
- GOAL POSTS MUST BE 76.1mm ODx4.5mm INSTALLED INTO THE SLEEVES WITHIN CONCRETE FOOTING. FOOTING TO BE 350mm DIAMETER x 700mm MINIMUM DEEP.
- 4. GOAL POSTS MUST BE INSTALLED SO THAT THE FACE OF THE POST IS POSITIONED FLUSH WITH THE INSIDE EDGE OF THE BASELINE SO NO PART OF THE POST IMPEDES ON THE PLAYING AREA OF THE
- 5. GOAL RINGS MUST HAVE LOOP.EYELETS FOR NET ATTACHMENT.
- 6. GOAL RINGS MUST NOT HAVE ARMS FROM RING TO POST (TO ALLOW FOR FULL HEIGHT PADDING).
- 7. NETS TO BE CHAIN WIRE NET.
- 8. PROVIDE FULL LENGTH HIGH DENSITY PADDING FOR EVERY POST WITH A MAXIMUM 50mm THICKNESS.
- 9. RINGS 380mm INTERNAL DIAMETER
- 15mm RING THICKNESS
- 150mm LENGTH CONNECTION TO POST
- POST TO RING CONNECTION TO BE HEAVY DUTY OR REINFORCED FOR PUBLIC ACCESS SETTING.
- STEEL HOOPS/EYELETS ARC WELDED TO THE UNDERSIDE OF THE RING TO ALLOW NET ATTACHMENT.
- 10. ALL GOAL POSTS, RINGS TO BE HOT DIPPED GALVANISED AND POWDER COAT WHITE.

### TENNIS COURT NET POSTS FOUNDATIONS:

600mm DIA x 1000mm MIN DEEP WITH A MINIMUM CONCRETE GRADE OF 25MPa POST (75mmx75mmx2.5mm POWDER COATED BLACK)TO BE REMOVABLE BY USE OF A 500mm LONG MIN. HOT DIPPED GALVANISED SLEEVE WITH DIMENSIONS 89x89x5mm. THE SLEEVES ARE TO INCORPORATE A HINGED HOT DIPPED GALVANISED (MILD STEEL) CAP (FLAP) WHICH WHEN IN THE CLOSED POSITION IS TO SIT PERFECTLY FLUSH WITH THE COURT SURFACE SO AS NOT TO PROVIDE A TRIP HAZARD. 10mm ABLEFLEX TO BE WRAPPED AROUND SLEEVE IN CONCRETE. FINISH ABLEFLEX 10mm BELOW TOP OF CONCRETE AND SEAL NEATLY WITH SIKA FLEX.

<u>SLEEVE INSTALLATION</u> - THE SLEEVE IS TO BE SET UP PRIOR TO THE CONCRETE SLAB FROM BEING POURED AND IS TO BE CAST IN-SITU AND DOWELED AS PER TYPICAL PICTURE. IF THE CONTRACTOR CHOOSES TO POUR THE SLAB FIRST AND CUT OUT THE AREA FOR THE SLEEVES REFER TO DETAIL CUT OUT METHOD. <u>NO</u> QUICKSET CONCRETE ALLOWED.

- PREMIUM INTERNAL WINDER TO BE BLACK POWDER COAT TENNIS POSTS. HANDLE MUST BE COLLAPSIBLE;
- FULL DROP DOWN NET WITH CENTRE HOOK AND STRAP;



Finished Surface Level


TYPICAL DETAIL FOR SLEEVE
INSTALLATION – CUT OUT METHOD
FOR CONCRETE PAVEMENT





PROJECT:
HARROW RECREATION RESERVE, HARROW
- PROPOSED REDEVELOPMENT WORKS OF
EXISTING COURTS - 2 MULTI PURPOSE
NETBALL/TENNIS & 1 TENNIS COURT

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DRAWING 1	TITLE: 2240	-07	
GOAL I & TENI		AILS FOR N	ETBALL
SHEET:	7 nf 29	REVISION:	Δ

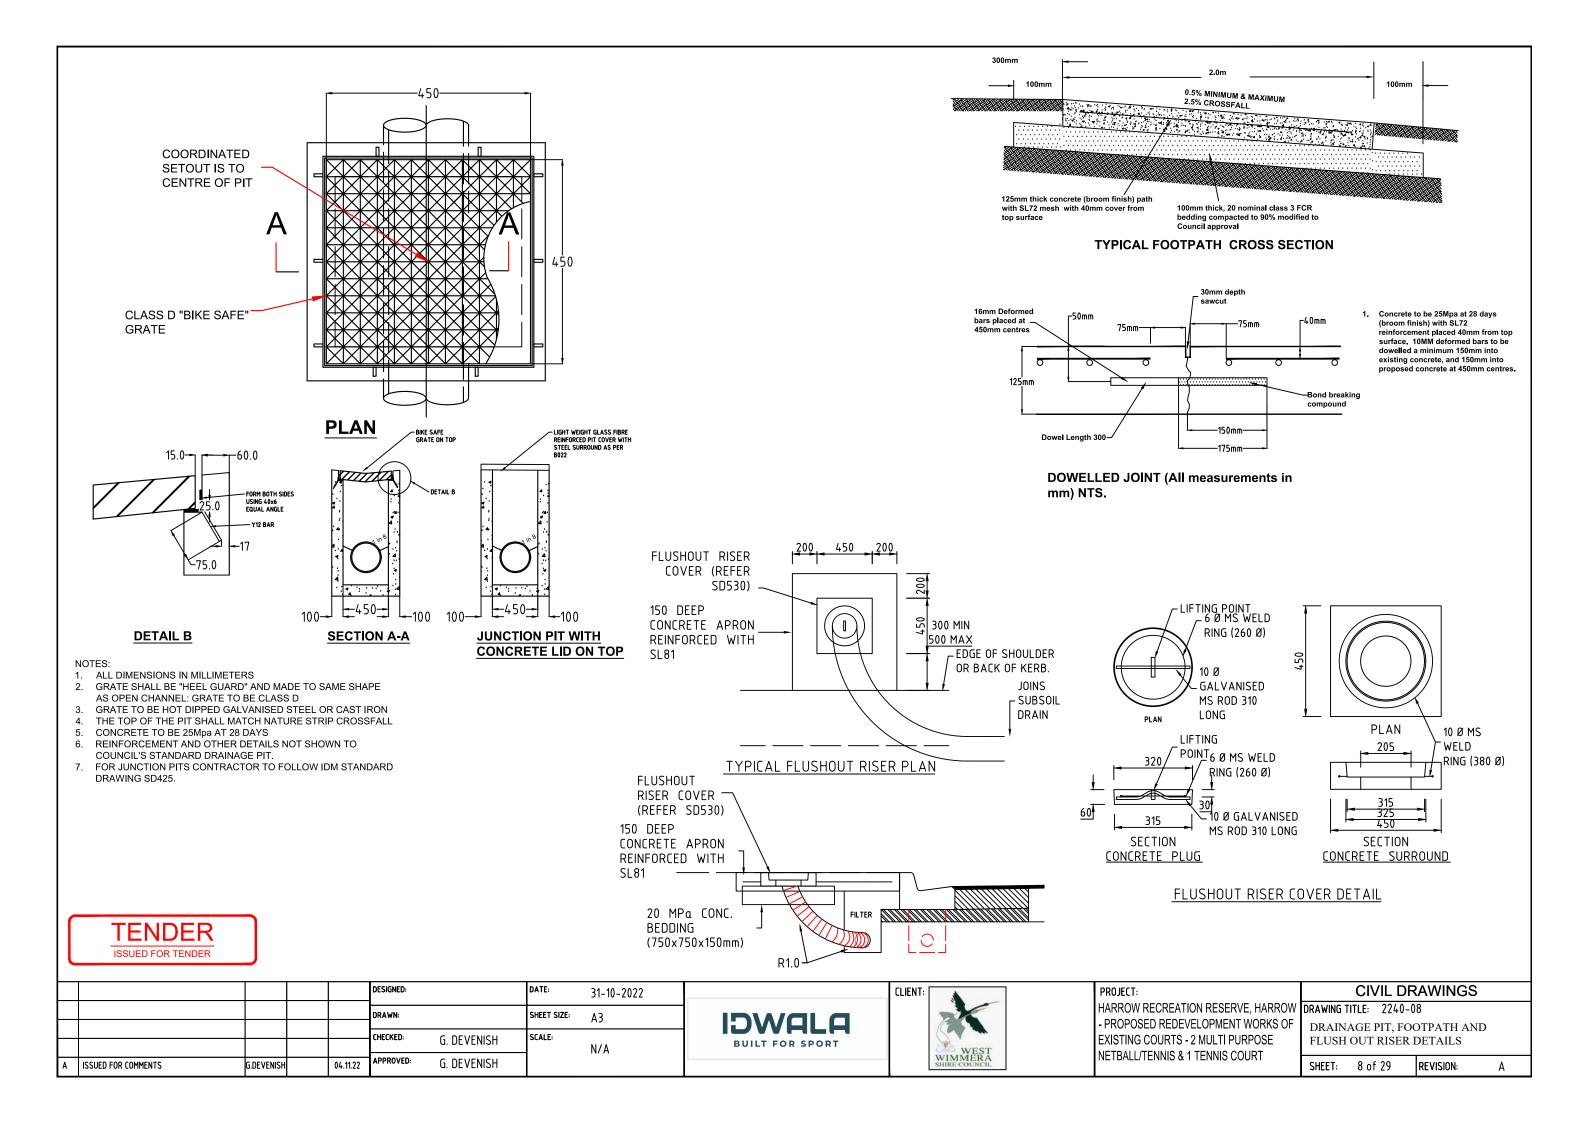



TYPICAL PROPOSED 16.0 x 2.0m SHELTER AND SEATING



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				DRAWN:		SHEET SIZE:	A3	
				CHECKED: G. DEVENISH		SCALE:		1
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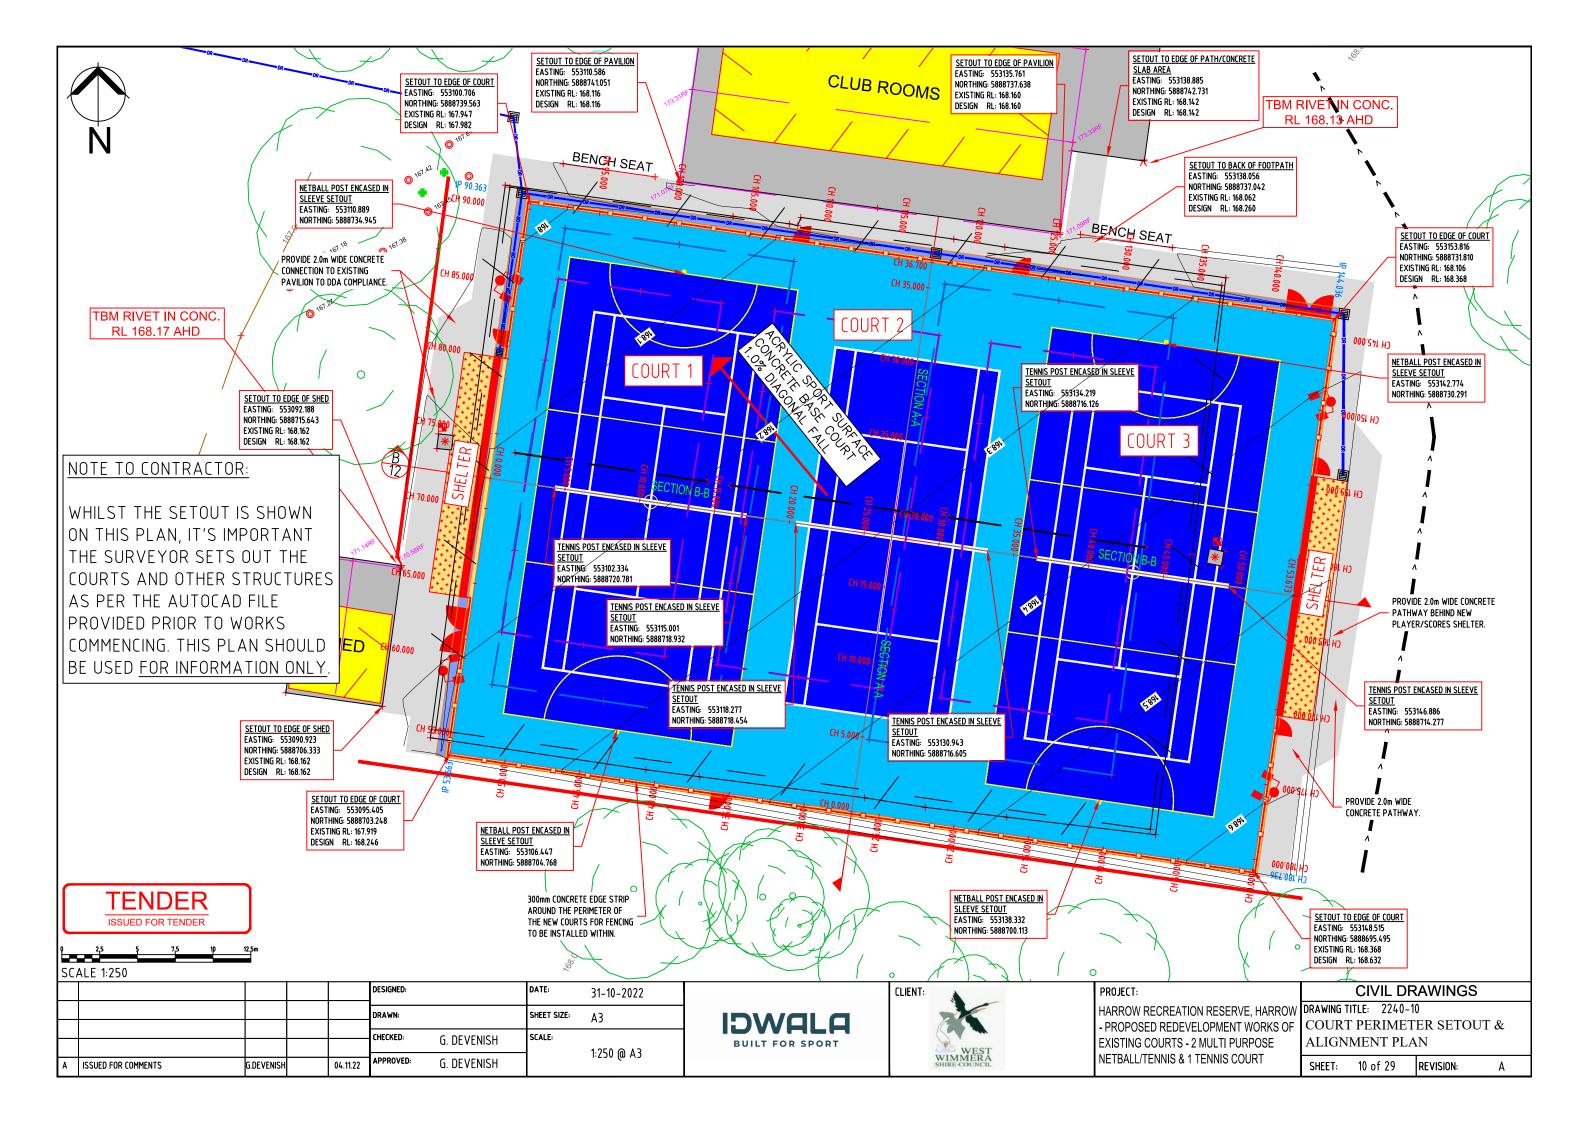






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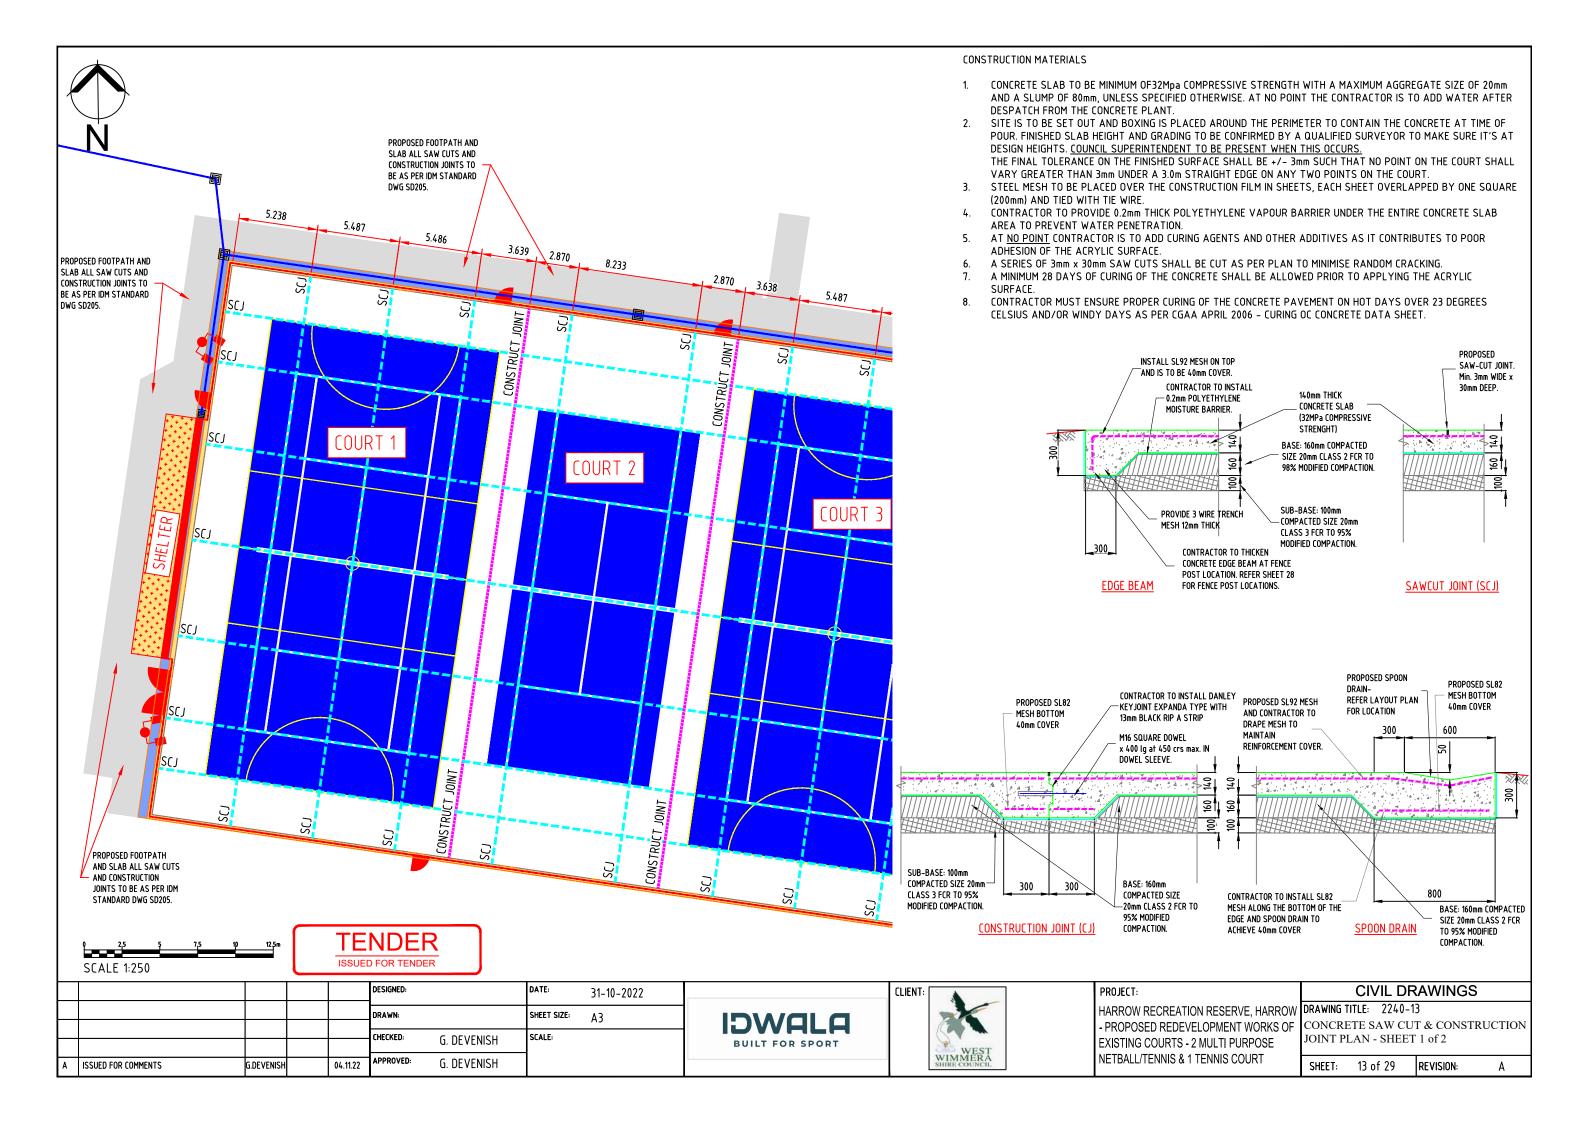
CIVIL DRAWINGS								
RAWING TITLE:	2240-09							
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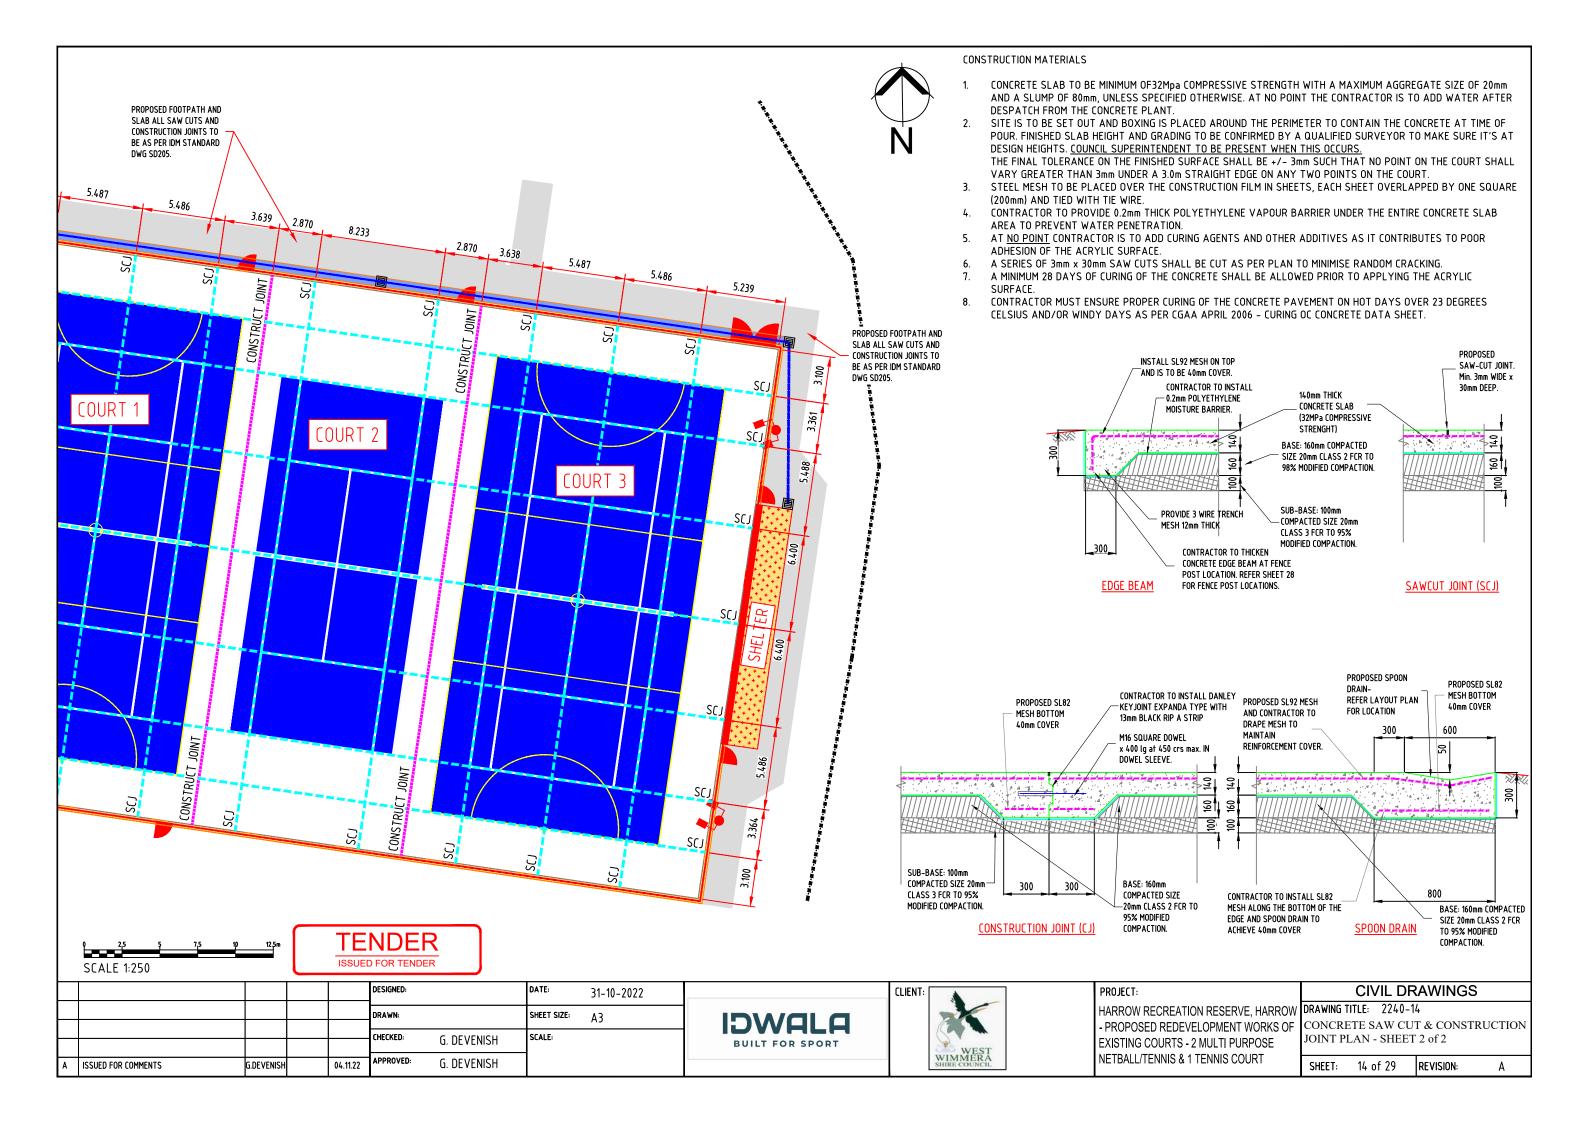
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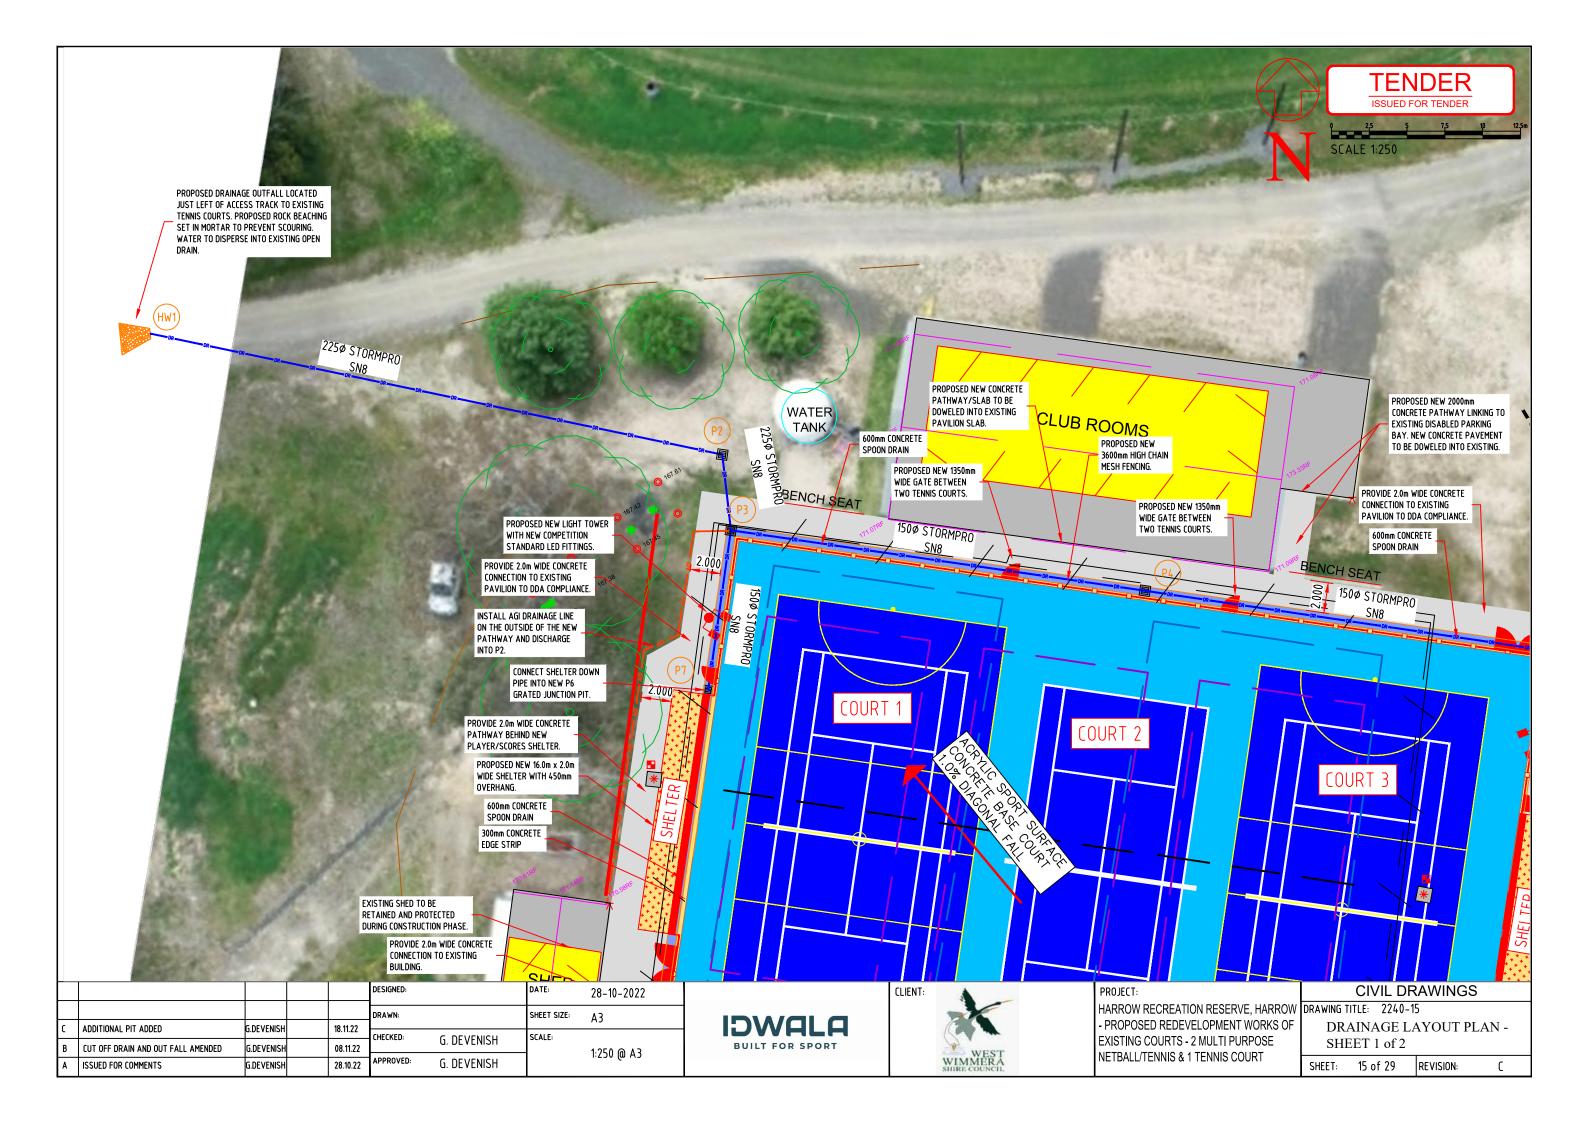











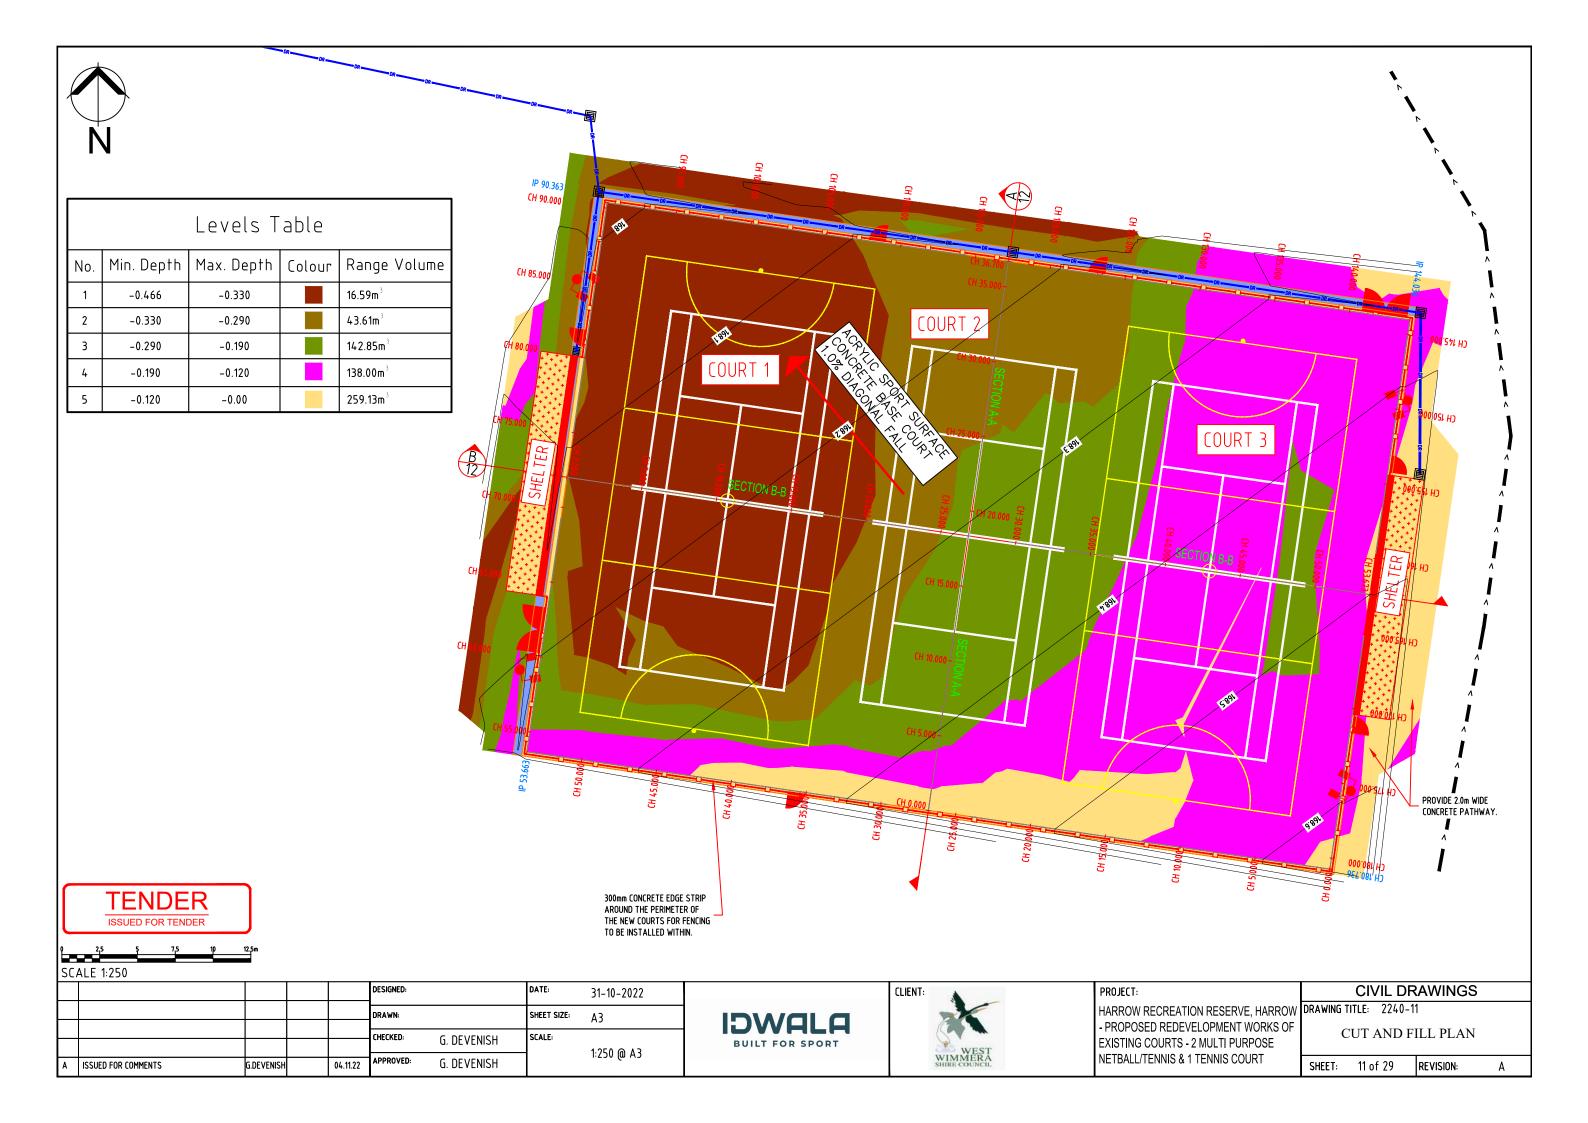


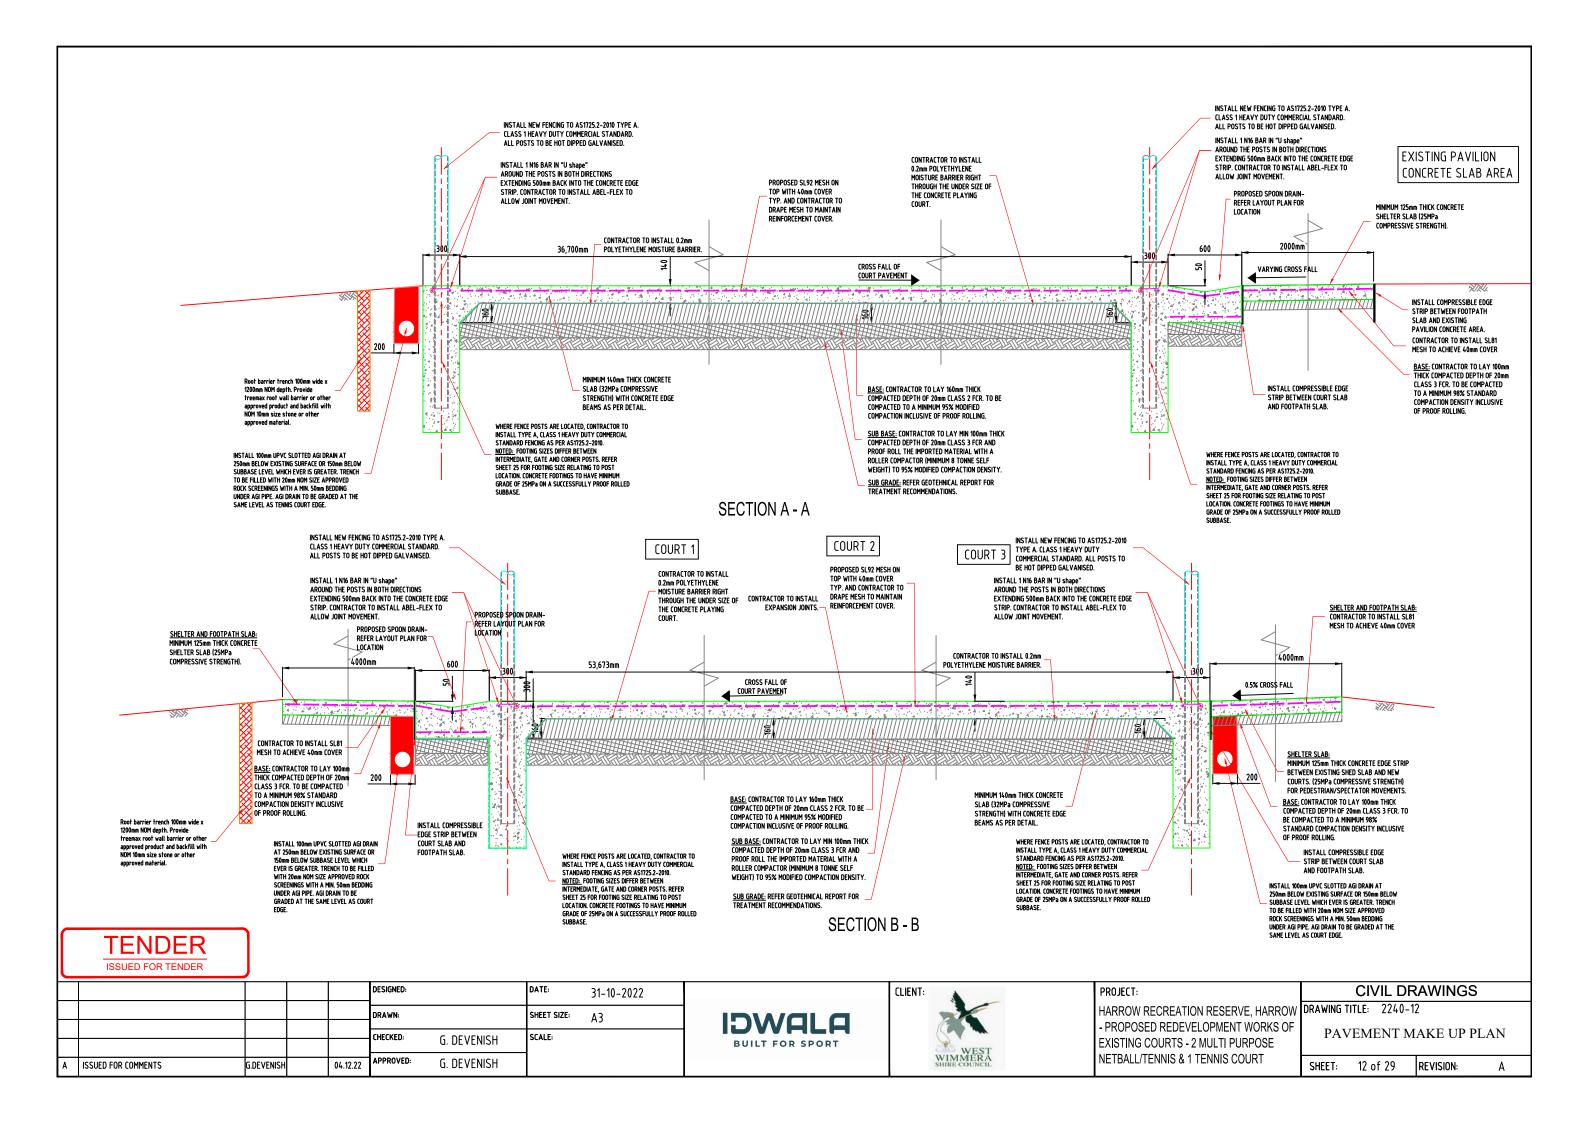

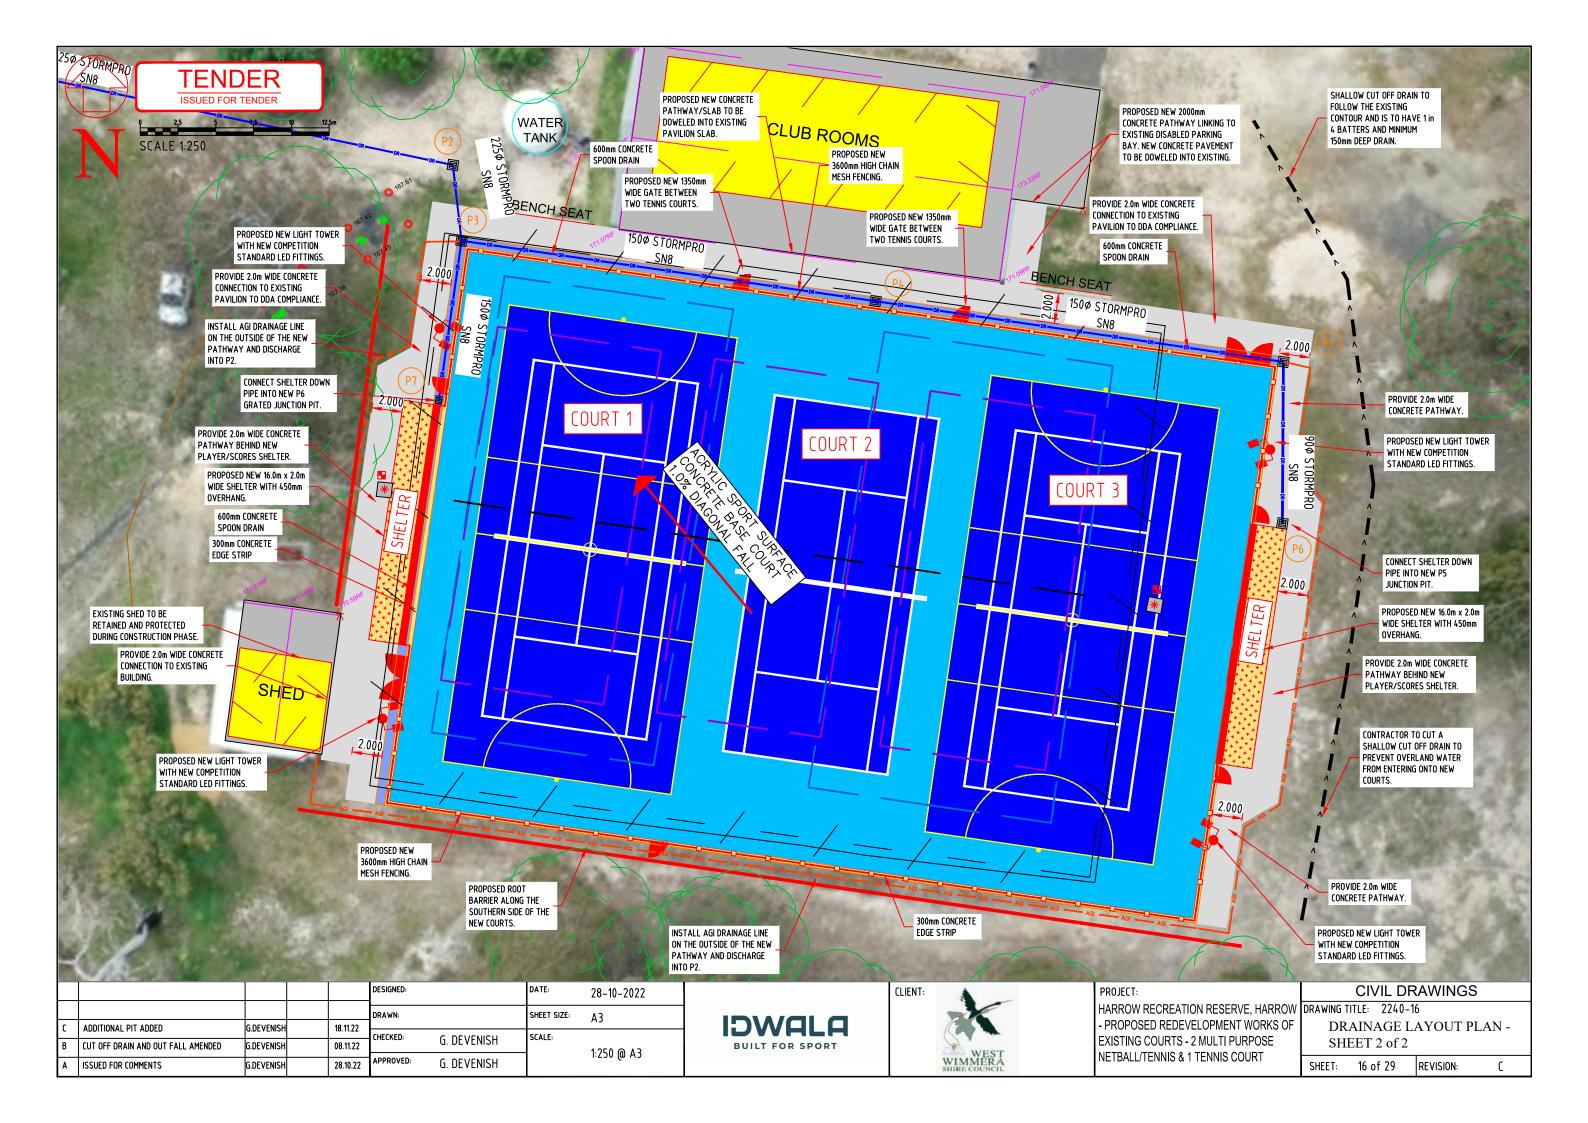

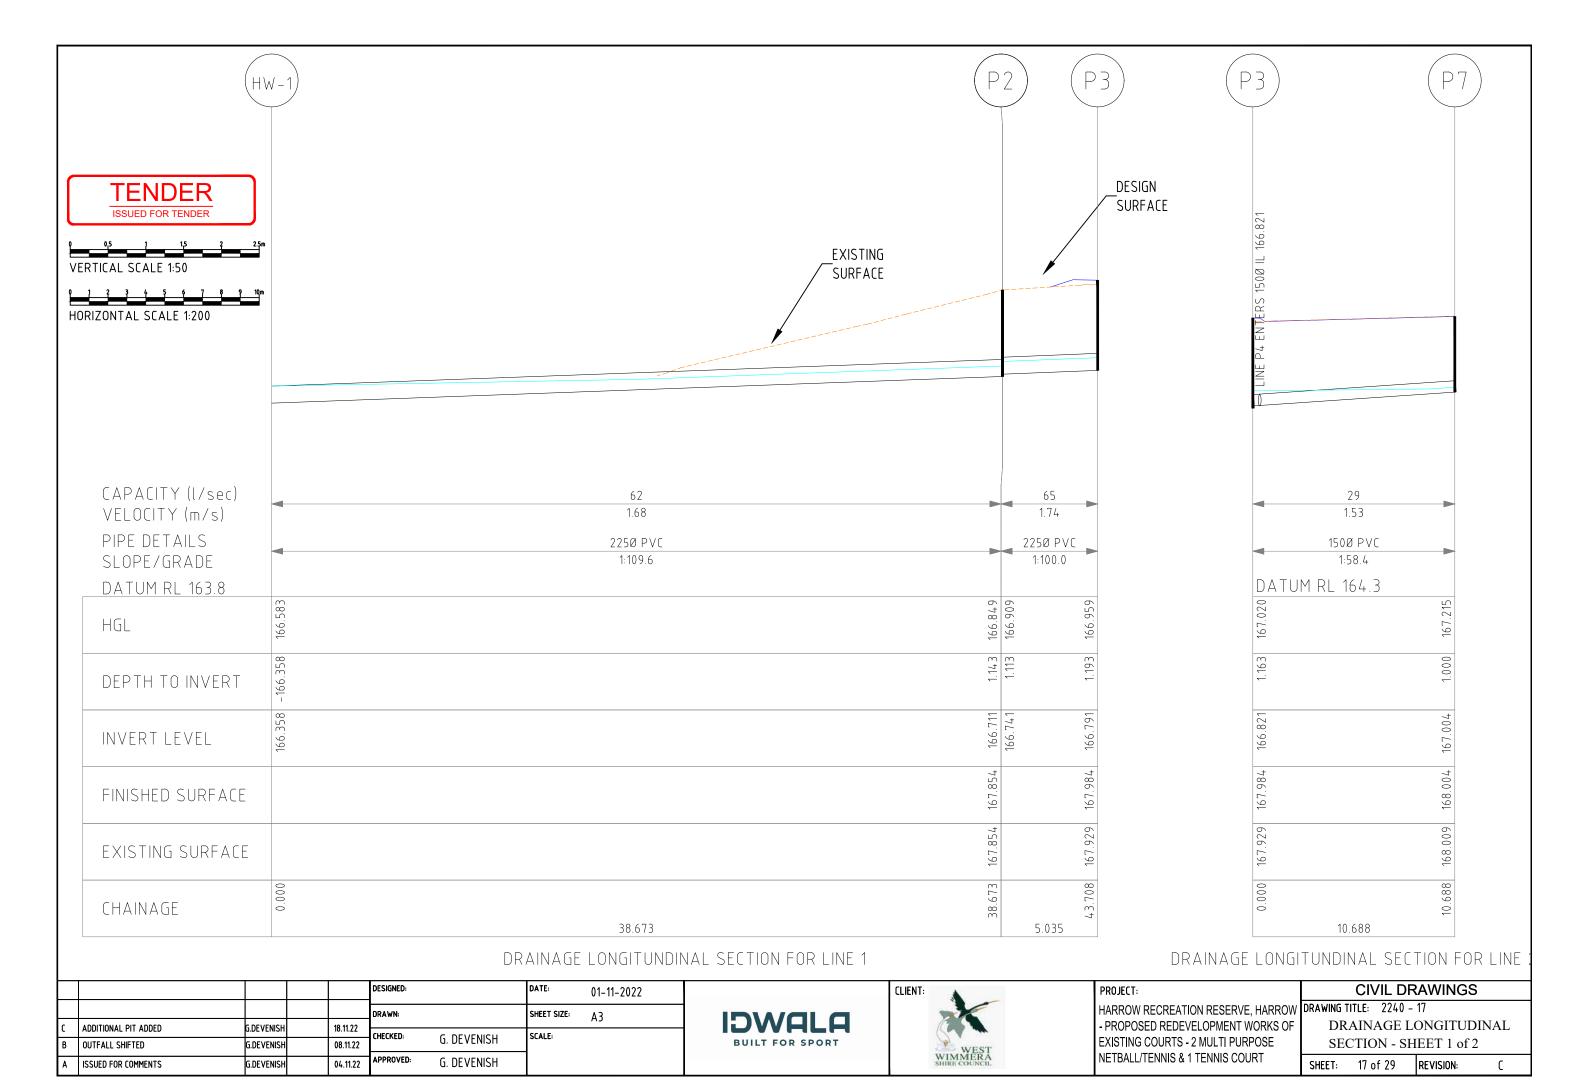

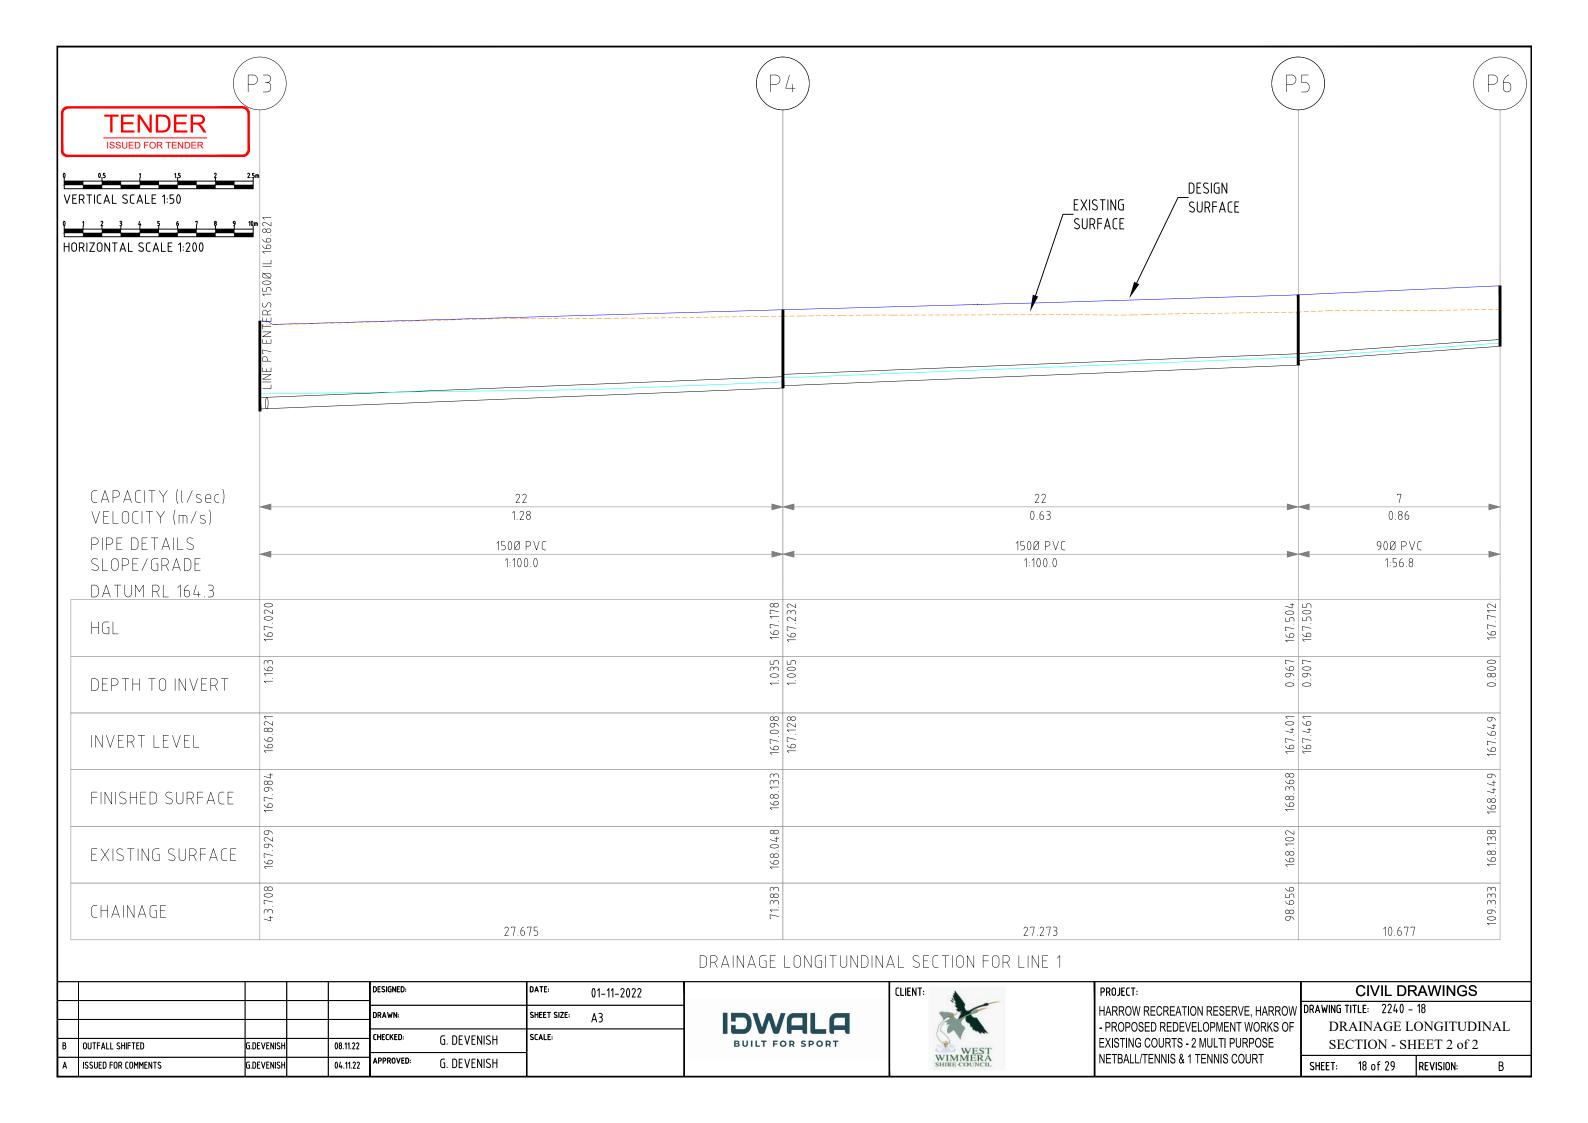

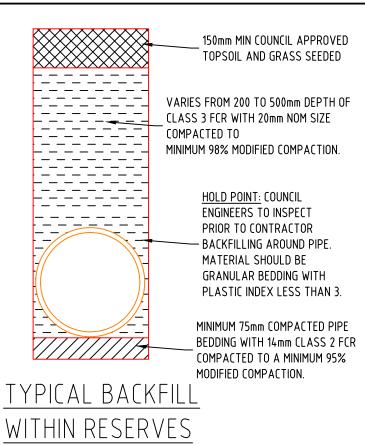

Pit Schedule – Drainage Layout – Harrow Recreation												
Pit No.	Pit Type	Pit Width-Internal	Pit Length-Internal	Outlet Diameter	Outlet Invert RL	Inlet Diameter	Inlet Invert RL	Pit Depth	Pit Lid Level	Easting	Northing	Comment
		(mm)	(mm)	(mm)	(m)	(mm)	(m)	(m)	(m)	(m)	(m)	
HW-1	HEADWALL					225	166.358			553061.76	5888753.293	
P2	GRATED JUNCTION PIT	450	450	225	166.711	225	166.741	1.143	167.854	553099.60	5888745.288	
P3	GRATED JUNCTION PIT	450	450	225	166.791	150	166.821	1.193	167.984	553100.17	5888740.286	
						150	166.821					
P4	GRATED JUNCTION	450	450	150	167.098	150	167.128	1.035	168.133	553127.55	5888736.288	
P7	GRATED JUNCTION PIT	450	450	150	167.004			1.000	168.004	553098.66	5888729.705	
P5	JUNCTION PIT	450	450	150	167.401	90	167.461	0.967	168.368	553154.53	5888732.275	
P6	JUNCTION PIT	450	450	90	167.649			0.800	168.449	553154.46	5888721.598	

MINIMUM 40mm THICK TYPE N ASPHALT WEARING COURSE.

150mm MIN COMPACTED DEPTH CLASS 2 FCR.
TOP (BASE) COMPACTED TO 98% MODIFIED
DENSITY RATIO. LOWER (SUB BASE) LAYER
COMPACTED TO 98% MODIFIED DENSITY RATIO

CLASS 3 FCR WITH 20mm NOM SIZE OR APPROVED EQUIVALENT MATERIAL. BACKFILL COMPACTED MECHANICALLY IN 150mm LAYERS USING VIBRATED RAMMER TO MINIMUM 98% MODIFIED DENSITY RATIO..

HOLD POINT: COUNCIL ENGINEERS TO INSPECT PRIOR TO CONTRACTOR BACKFILLING

- AROUND PIPE. MATERIAL SHOULD BE GRANULAR BEDDING WITH PLASTIC INDEX LESS THAN 3.

MINIMUM 75mm COMPACTED PIPE BEDDING WITH 14mm CLASS 2 FCR COMPACTED TO A MINIMUM 95% MODIFIED COMPACTION.

TYPICAL BACKFILL

UNDER ROAD

PAVEMENT

TENDER

ISSUED FOR TENDER

				DESIGNED:		DATE:	03-11-2022
				DRAWN:		SHEET SIZE:	А3
В	ADDITIONAL PIT ADDED	G.DEVENISH	18.11.22	CHECKED:	G. DEVENISH	SCALE:	
A	ISSUED FOR COMMENTS	G.DEVENISH	04.11.22	APPROVED:	APPROVED: G. DEVENISH		





PROJECT:	
HARROW RECREATION RESERVE, HARROW	DF
- PROPOSED REDEVELOPMENT WORKS OF	
EXISTING COURTS - 2 MULTI PURPOSE	
NETBALL/TENNIS & 1 TENNIS COURT	۲,


CIVIL DRAWINGS

DRAWING TITLE: 2240-19

DRAINAGE PIT SCHEDULE &

BACKFILL DETAIL

SHEET: 19 of 29 REVISION: B

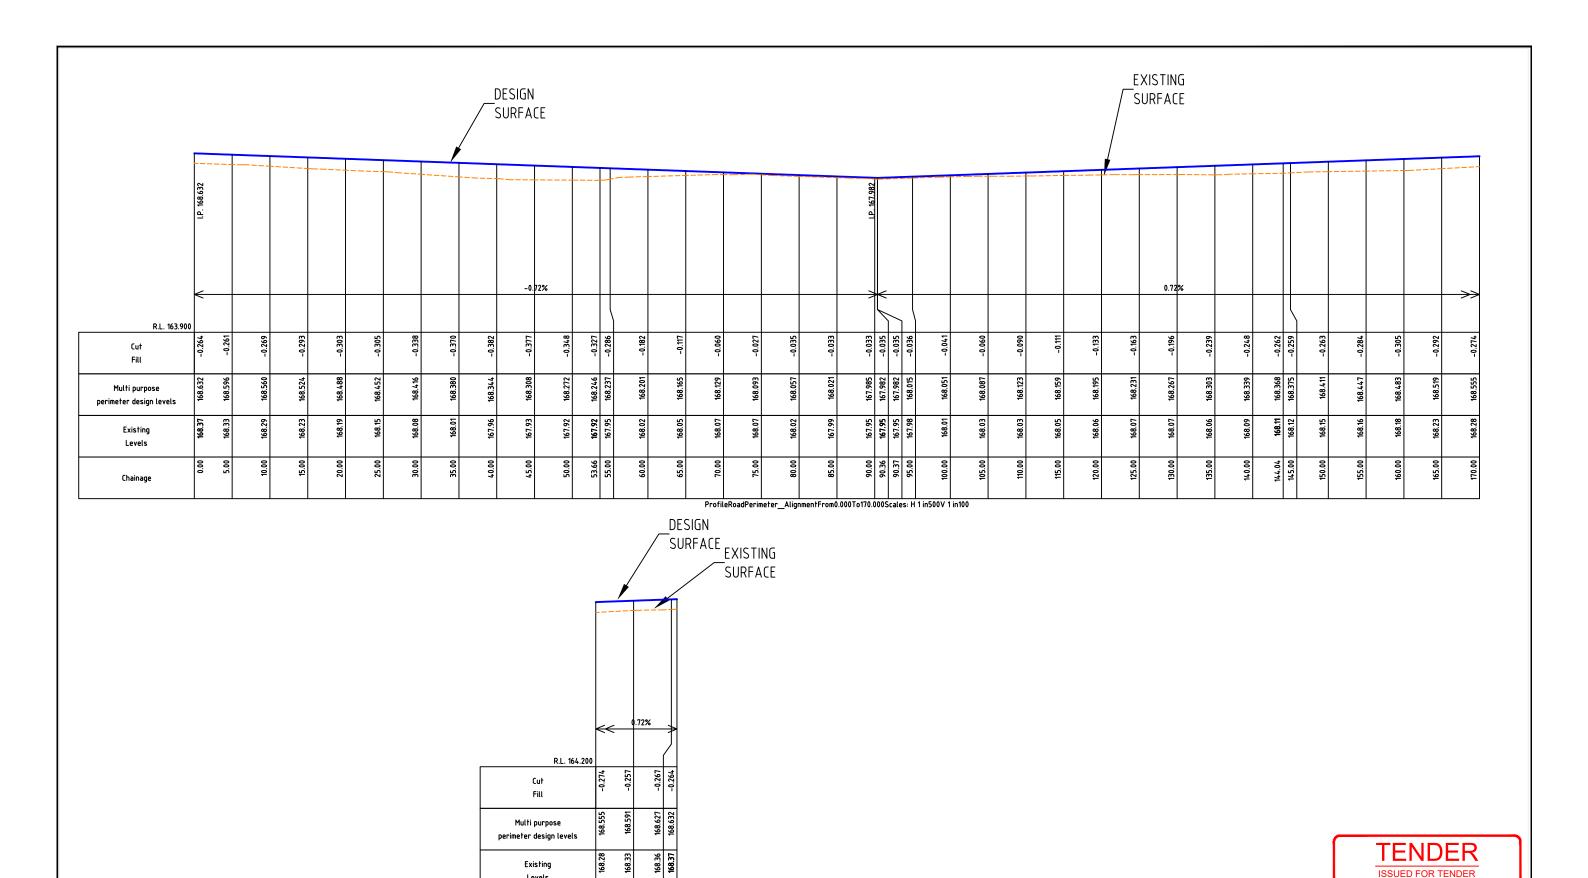

DESIGNED: DATE: 03-11-2022 DRAWN: SHEET SIZE: Α3 CHECKED: SCALE: G. DEVENISH 04.11.22 APPROVED: G. DEVENISH ISSUED FOR COMMENTS G.DEVENISH

Levels

175.00

ProfileRoadPerimeter\_AlignmentFrom170.000To180.736Scales: H 1 in500V 1 in100





PROJECT:	
EXISTING COURTS - 2 MULTI PURPOSE	DRAWIN MUL' COUF LONG
NETBALL/TENNIS & 1 TENNIS COURT	CHEET

CIV	/IL DRAWINGS	
/ING TITLE:	2240-20	
LTI PURP	OSE NETBALL/TENNIS/	
JRT PERI	METER	


0 5 10 15 20 25m

LONGITUDINAL SECTION SHEET: 20 of 29 REVISION:


VERTICAL SCALE 1:100

HORIZONTAL SCALE 1:500

HARROW RECREATION RES
HARROW RECREATION RES - PROPOSED REDEVELOPM EXISTING COURTS - 2 MULT
EXISTING COURTS - 2 MULT
NIETBALL (TENDUO A 4 TENDU

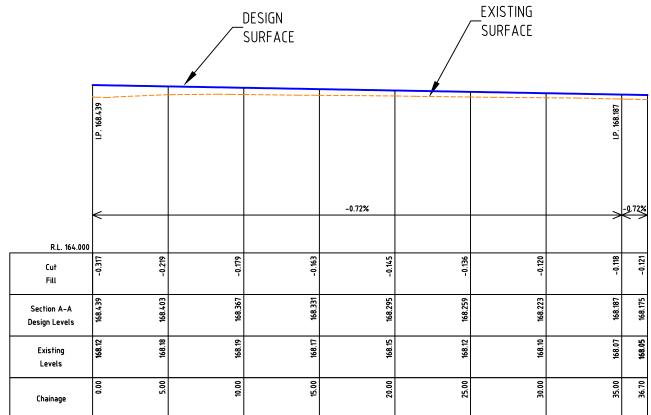

ProfileRoadSection A\_A\_AlignmentFrom0.000To36.700Scales: H 1 in250V 1 in100

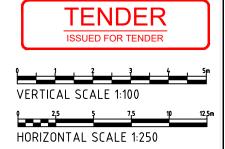


				DESIGNED:		DATE:	03-11-2022
				DRAWN:		SHEET SIZE:	A3
				CHECKED:	G. DEVENISH	SCALE:	
				G. DE VENISH			
Α	ISSUED FOR COMMENTS	G.DEVENISH	04.11.22	APPROVED:	G. DEVENISH		







PROJECT:	CIVIL DR
HARROW RECREATION RESERVE, HARROW	DRAWING TITLE: 2240-2
- PROPOSED REDEVELOPMENT WORKS OF	SECTION A-A
EXISTING COURTS - 2 MULTI PURPOSE	LONGITUDIN
NETBALL/TENNIS & 1 TENNIS COURT	SHEET: 21 of 29


		CI\	/IL DR	AWINGS				
W	DRAWING T	ITLE:	2240-2	1				
F	SECTION A-A							
	LO	ONG!	TUDIN	AL SECTION				
	SHEET:	21 o	f 29	REVISION:	Α			

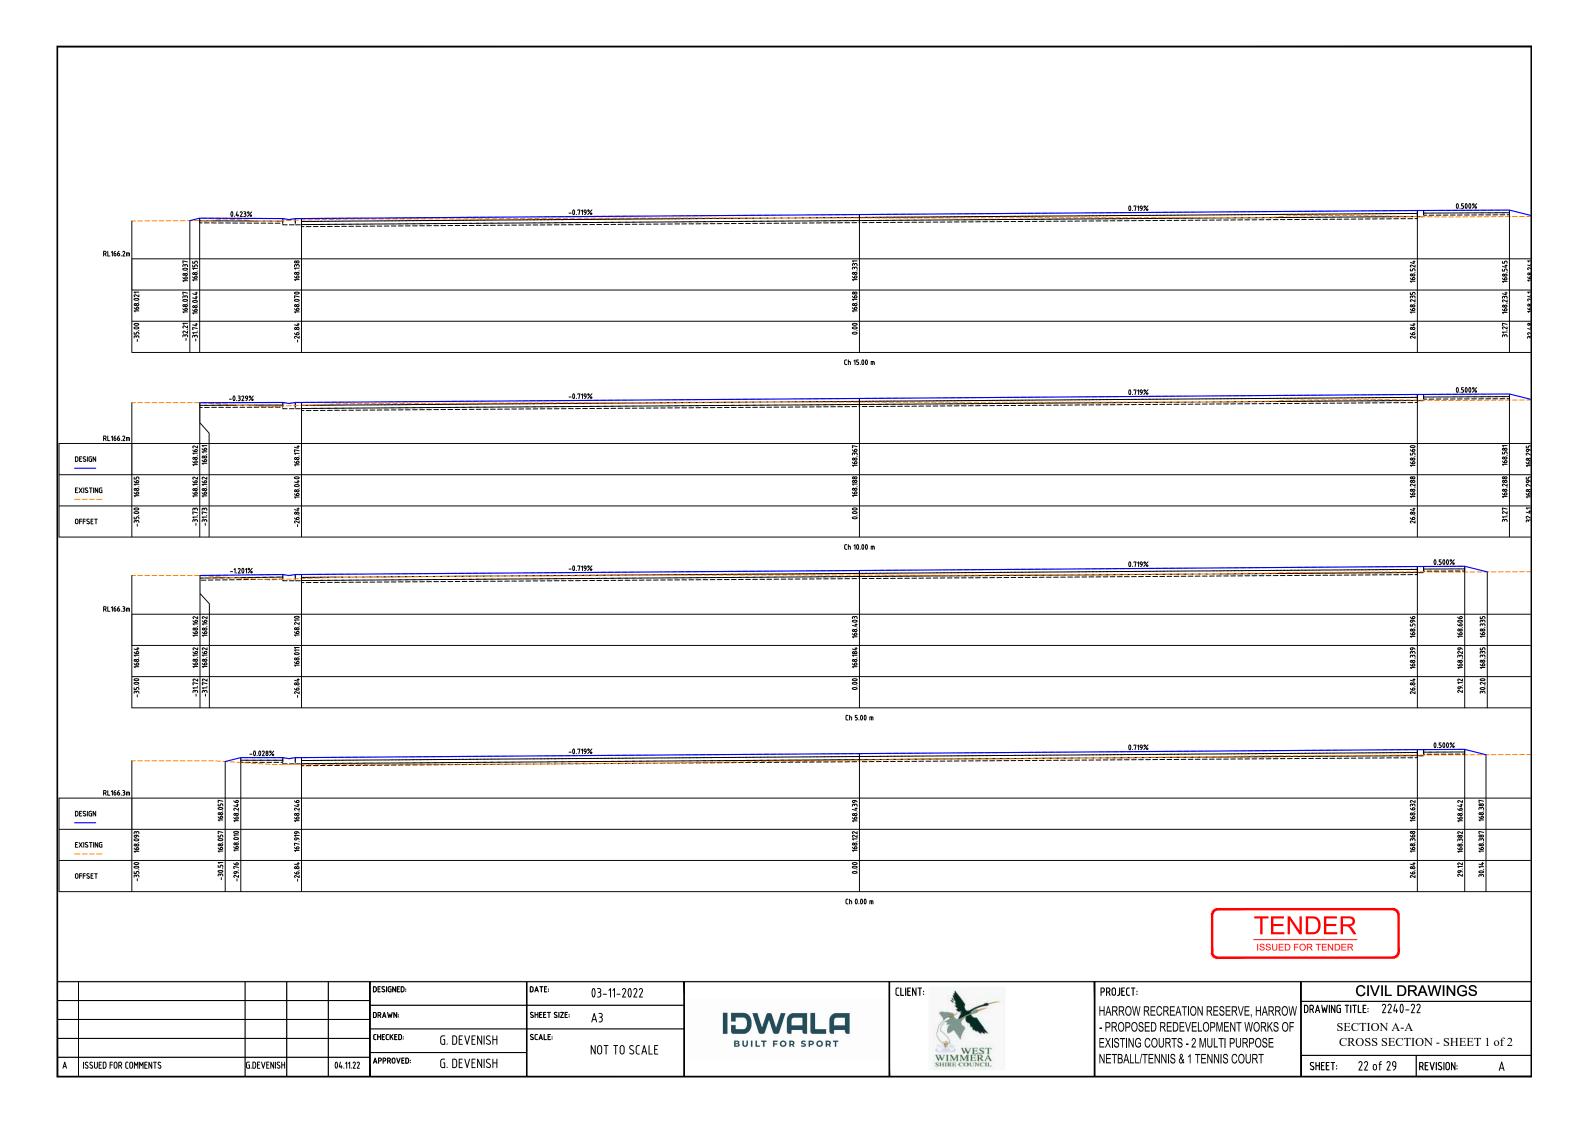

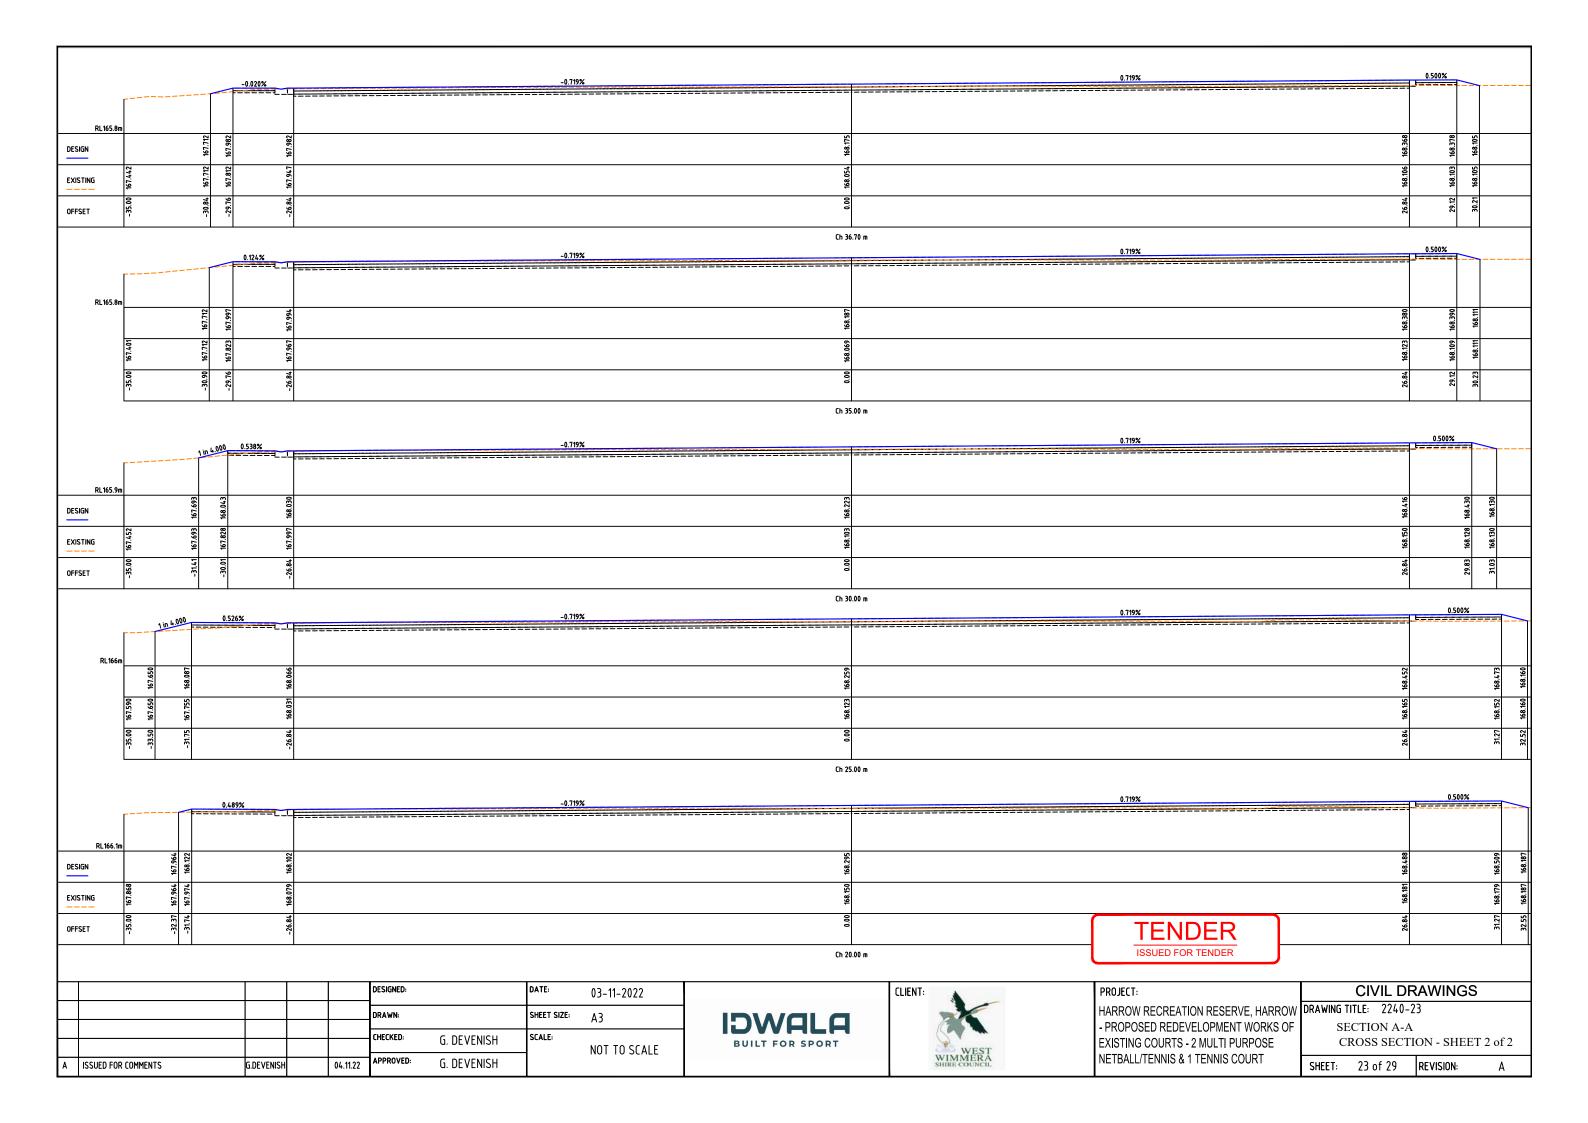

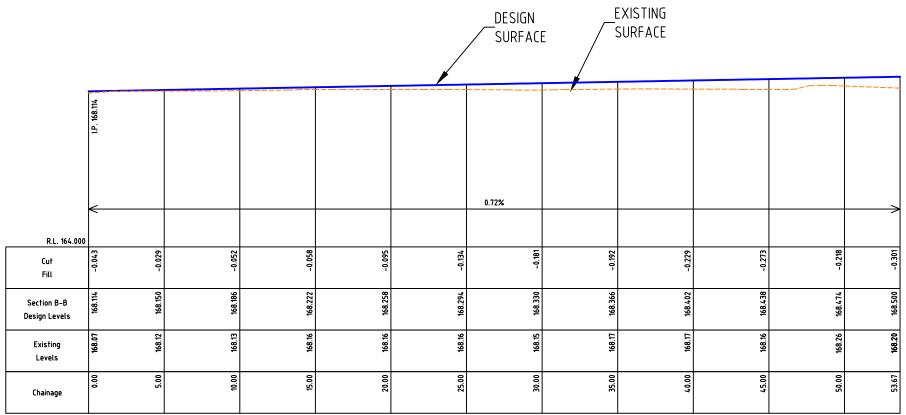

ProfileRoadSection B-B\_AlignmentFrom0.000To53.673Scales: H 1 in250V 1 in100

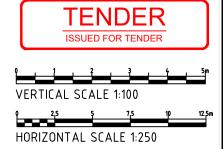



				DESIGNED:		DATE:	02-11-2022
				DRAWN:		SHEET SIZE:	A3
				CHECKED:	G. DEVENISH	SCALE:	
Α	ISSUED FOR COMMENTS	G.DEVENISH	04.11.22	APPROVED:	APPROVED: G. DEVENISH		





PROJECT:		CIV	IL DR	AWINGS
HARROW RECREATION RESERVE, HARROW	DRAWING T	ITLE:	2240-2	4
- PROPOSED REDEVELOPMENT WORKS OF	SE	ECTIC	N B-B	
EXISTING COURTS - 2 MULTI PURPOSE	Lo	ONGI	TUDIN	AL SECTION
NETBALL/TENNIS & 1 TENNIS COURT	SHEET:	24 c	f 29	REVISION:

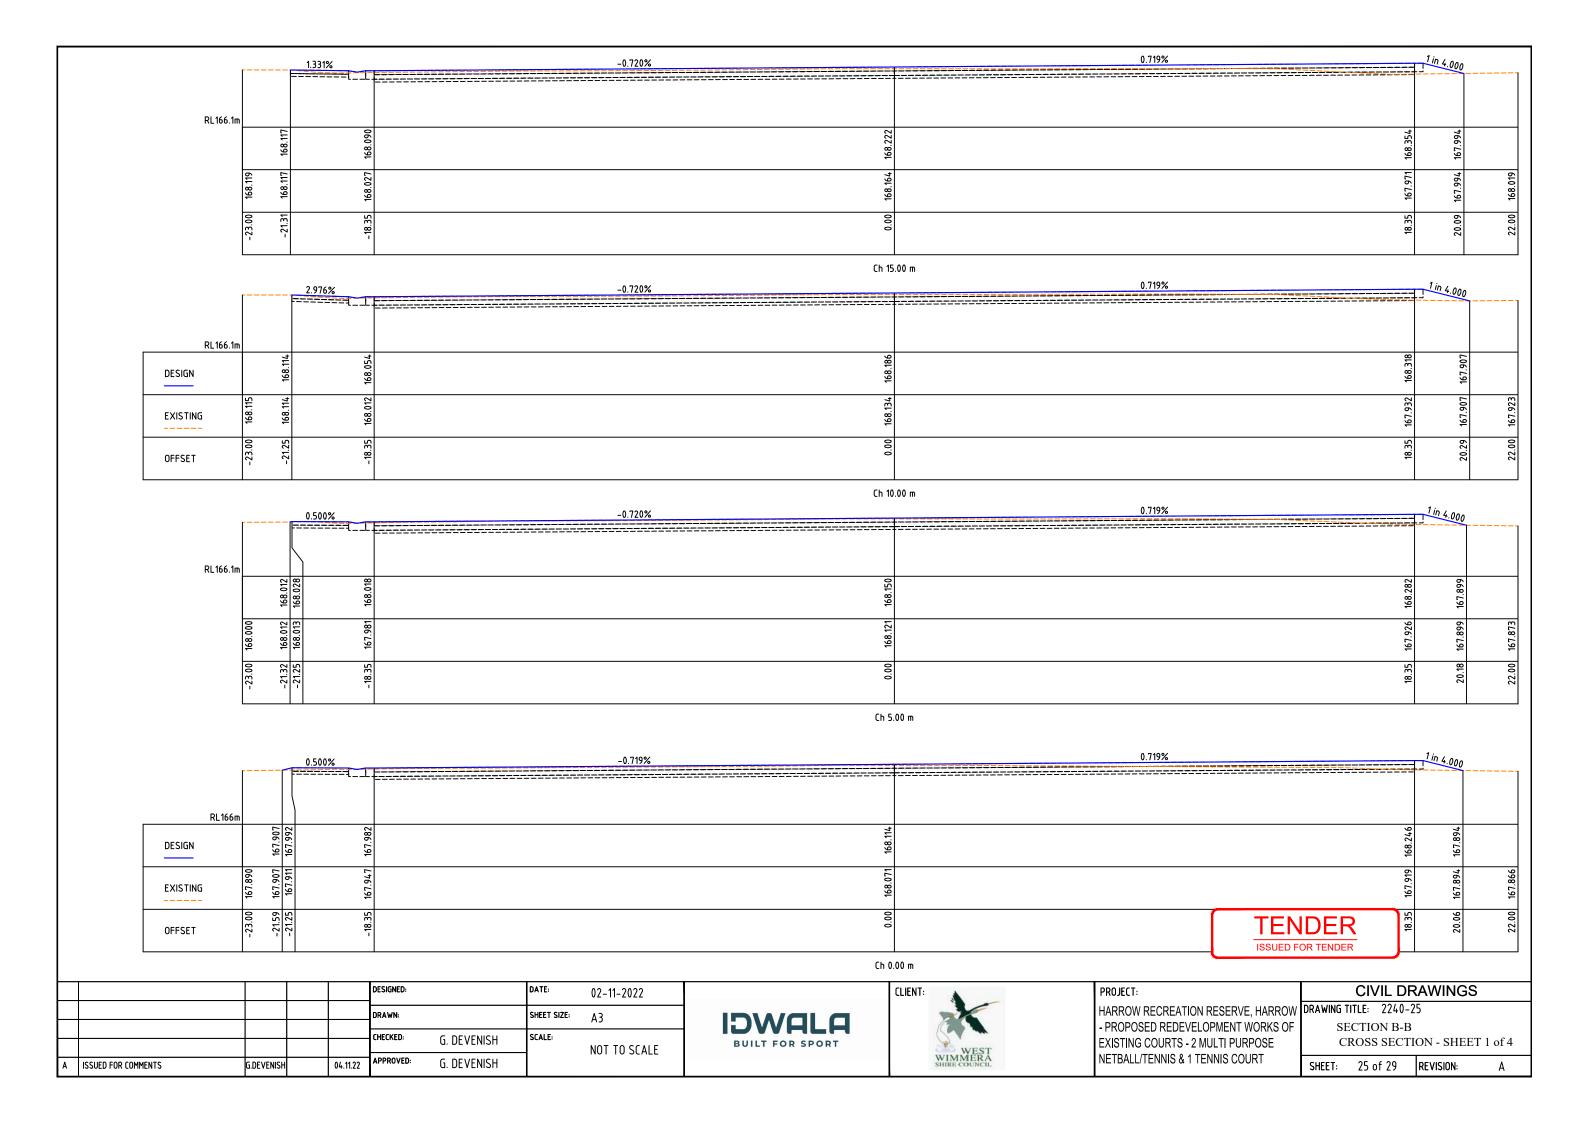

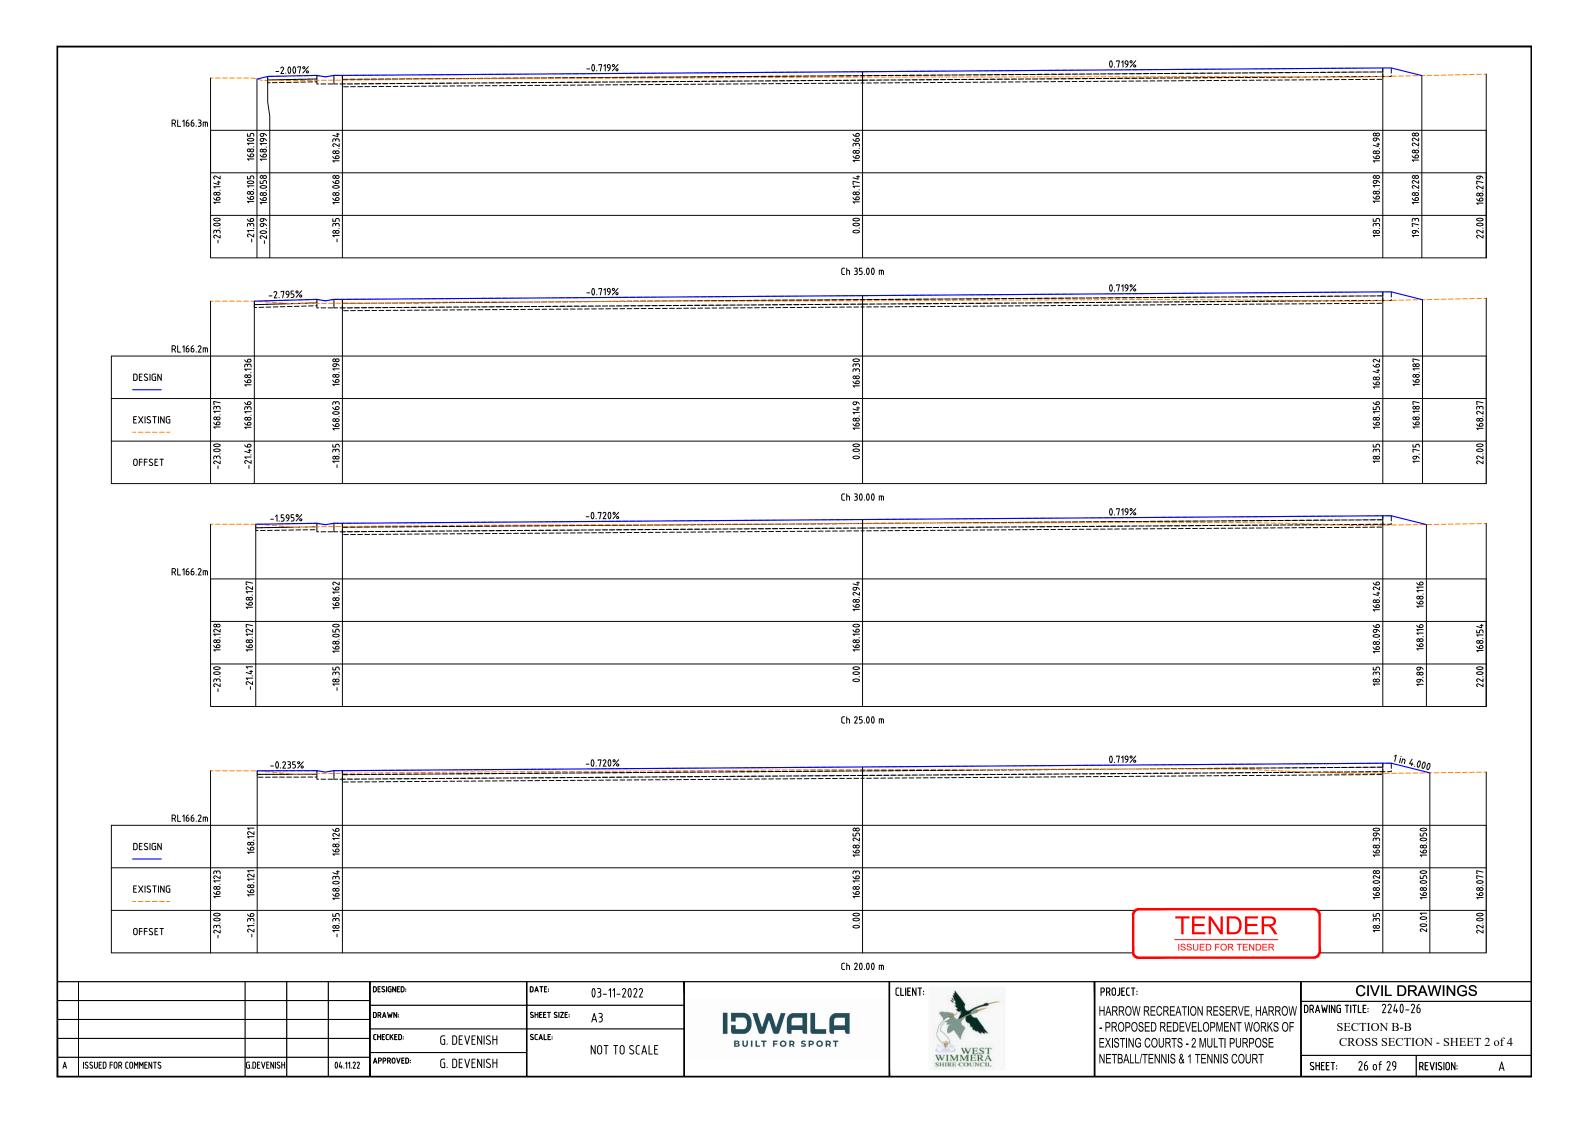

			0.500%	-0.719%	I		
RL166.4π							
	168.064	168.316	168.306	168.438	168.570	168.329	
	168.055 168.064	168.071	168.065	168.165	168.308	168.329	168.368
	-23.00	-21.25	-18.35	0.00	18.35	19.61	22.00

Ch 45.00 m

			0.500%	-0.719%	0.719%		<del></del> -
RL166	6.3m					<u> </u>	
DESIGN	168.068	168.280	168.270	168.4.02	168.534	168.269	
EXISTING	168.081	168.061	168.071	168.173	168.24.7	168.269	168.309
OFFSET	-23.00	-21.25	-18.35	0.00	18.35	19.71	22.00

Ch 40.00 m



				DESIGNED:		DATE:	02-11-2022
				DRAWN:		SHEET SIZE:	A3
				CHECKED: G. DEVENISH		SCALE:	NOT TO SCALE
Α	ISSUED FOR COMMENTS	G.DEVENISH	04.11.22	APPROVED:	G. DEVENISH		NOT TO SCALE





PROJECT:	
HARROW RECREATION RESERVE, HARROW	DRAWING 1
- PROPOSED REDEVELOPMENT WORKS OF	SI
EXISTING COURTS - 2 MULTI PURPOSE	C
NETBALL/TENNIS & 1 TENNIS COURT	SHEET:

CIVIL DRAWINGS							
DRAWING TITLE: 2240-27							
SECTION B-B							
CROSS SECTION - SHEET 3 of 4							
SHEET:	27 o	f 29	REVISION:	А			

		0.500%	-0.719%	0.719%	
RL166.4m					
	168.078	168.368	168.500	168.632	168.383
	168.075	168.083	168.199	899:899.	168.383
	-23.00	-21.25	00.0	18.35	19.65

Ch 53.67 m

		0.500	% 	-0.719%	0.720%		1
RL166.4		_=====	==+L				
DESIGN	168.064	168.352	168.342	168.474	909:891	168.358	
EXISTING	168.06 168.064	168.069	168.092	168.256	778:891	168.358	168.384
OFFSET	-23.00	-21.25	-18.35	0.00	18.35	19.64	22.00

Ch 50.00 m



				DESIGNED:		DATE:	22-08-2022
				DRAWN:		SHEET SIZE:	А3
				CHECKED: G. DEVENISH		SCALE:	NOT TO SCALE
A	ISSUED FOR COMMENTS	G.DEVENISH	29.08.22	APPROVED:	G. DEVENISH		NOT TO SCALE





PROJECT:	
HARROW RECREATION RESERVE, HARROW	DRA
- PROPOSED REDEVELOPMENT WORKS OF	
EXISTING COURTS - 2 MULTI PURPOSE	
NETBALL/TENNIS & 1 TENNIS COURT	SH
	PROJECT: HARROW RECREATION RESERVE, HARROW - PROPOSED REDEVELOPMENT WORKS OF EXISTING COURTS - 2 MULTI PURPOSE NETBALL/TENNIS & 1 TENNIS COURT

CIVIL DRAWINGS							
DRAWING TITLE: 2240-28							
SE	SECTION B-B						
CROSS SECTION - SHEET 4 of 4							
SHEET:	28 o	f 29	REVISION:	Α			

